

ELECTRICAL			
LIGHT & POWER FEEDERS			
ALTERATIONS TO MAIN BLDG			
FOR THE FREE PUBLIC LIBRARY			
WASHINGTON ST NEWARK N.J.			
679	SCALE	NONE	DATE APR. 1, 50
E.T.O.	EPPLE & SEAMAN		
ARCHITECTS & ENGINEERS			901 BROAD STREET NEWARK 2 N.J.














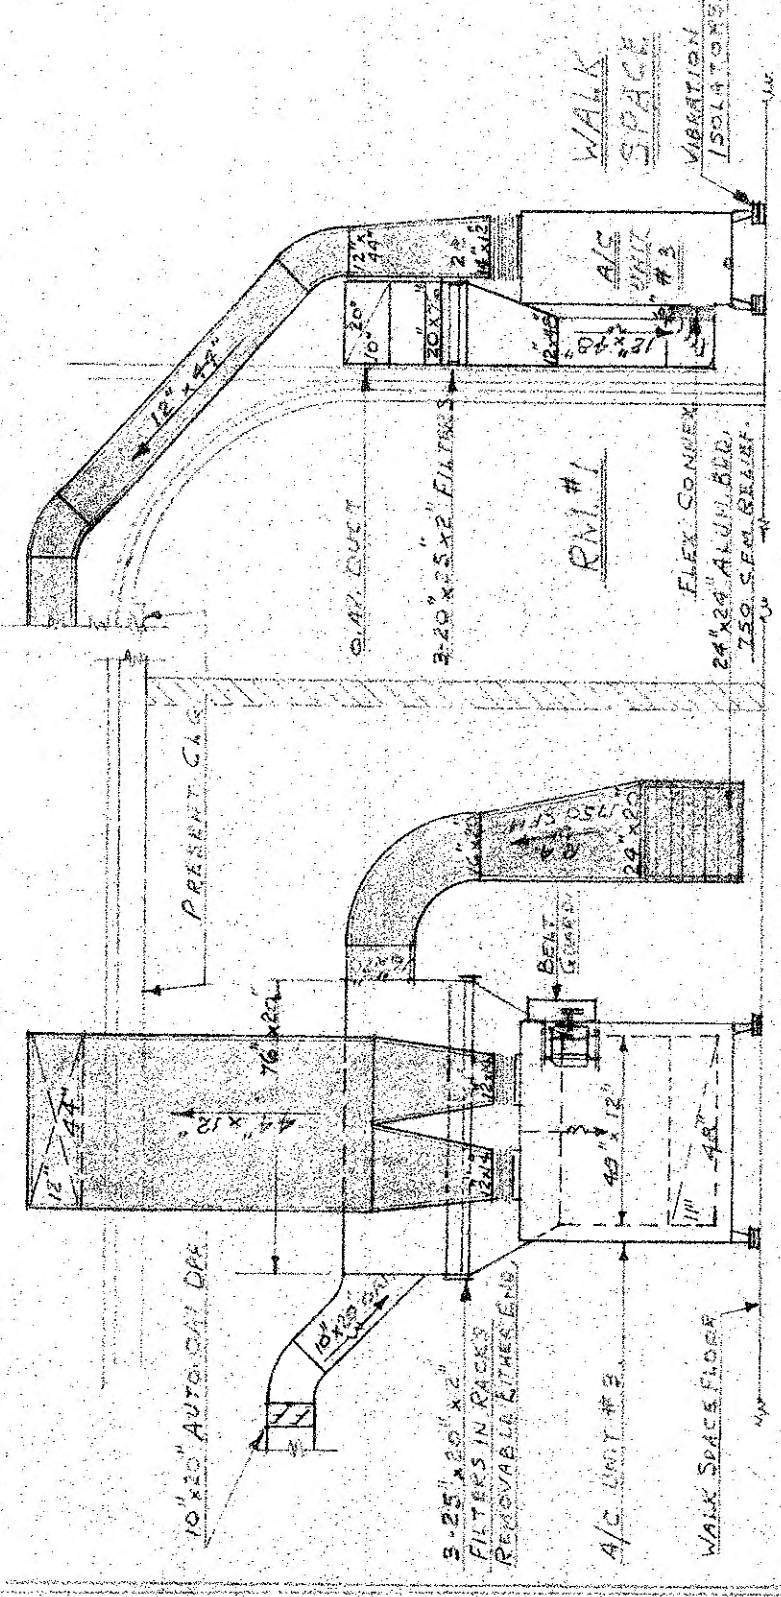


REAR ELEVATION  
A/C UNIT #3  
SCALE 1/4" = 1'-0"

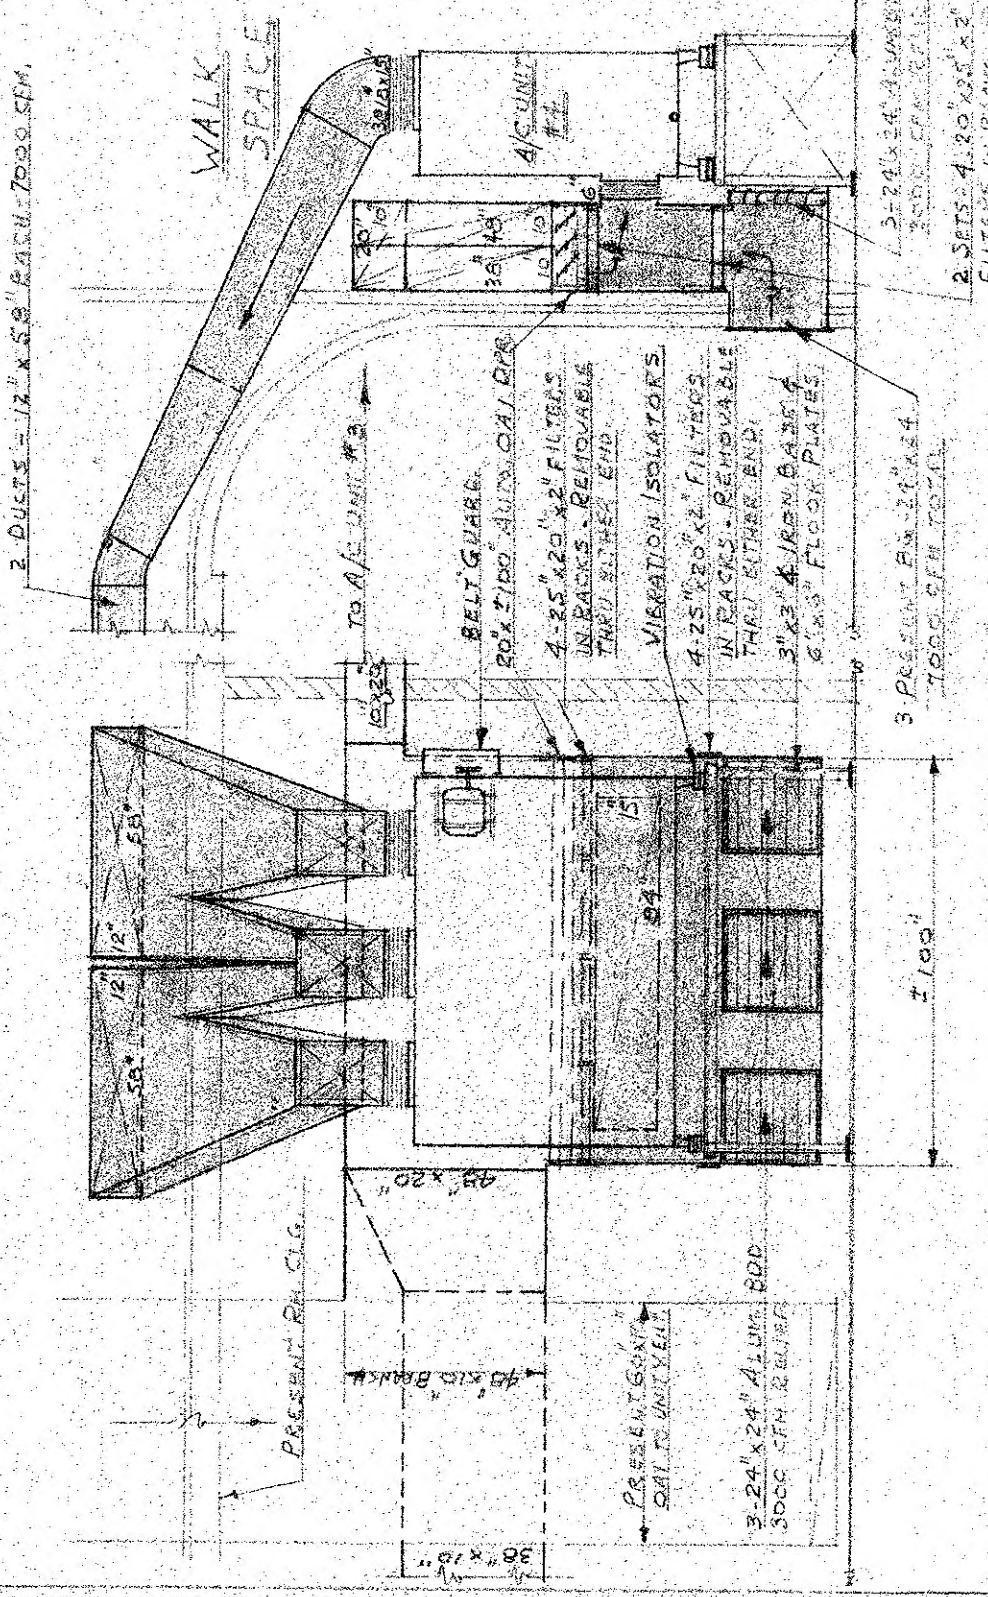


REAR ELEVATION  
A/C UNIT #4  
SCALE 1/4" = 1'-0"

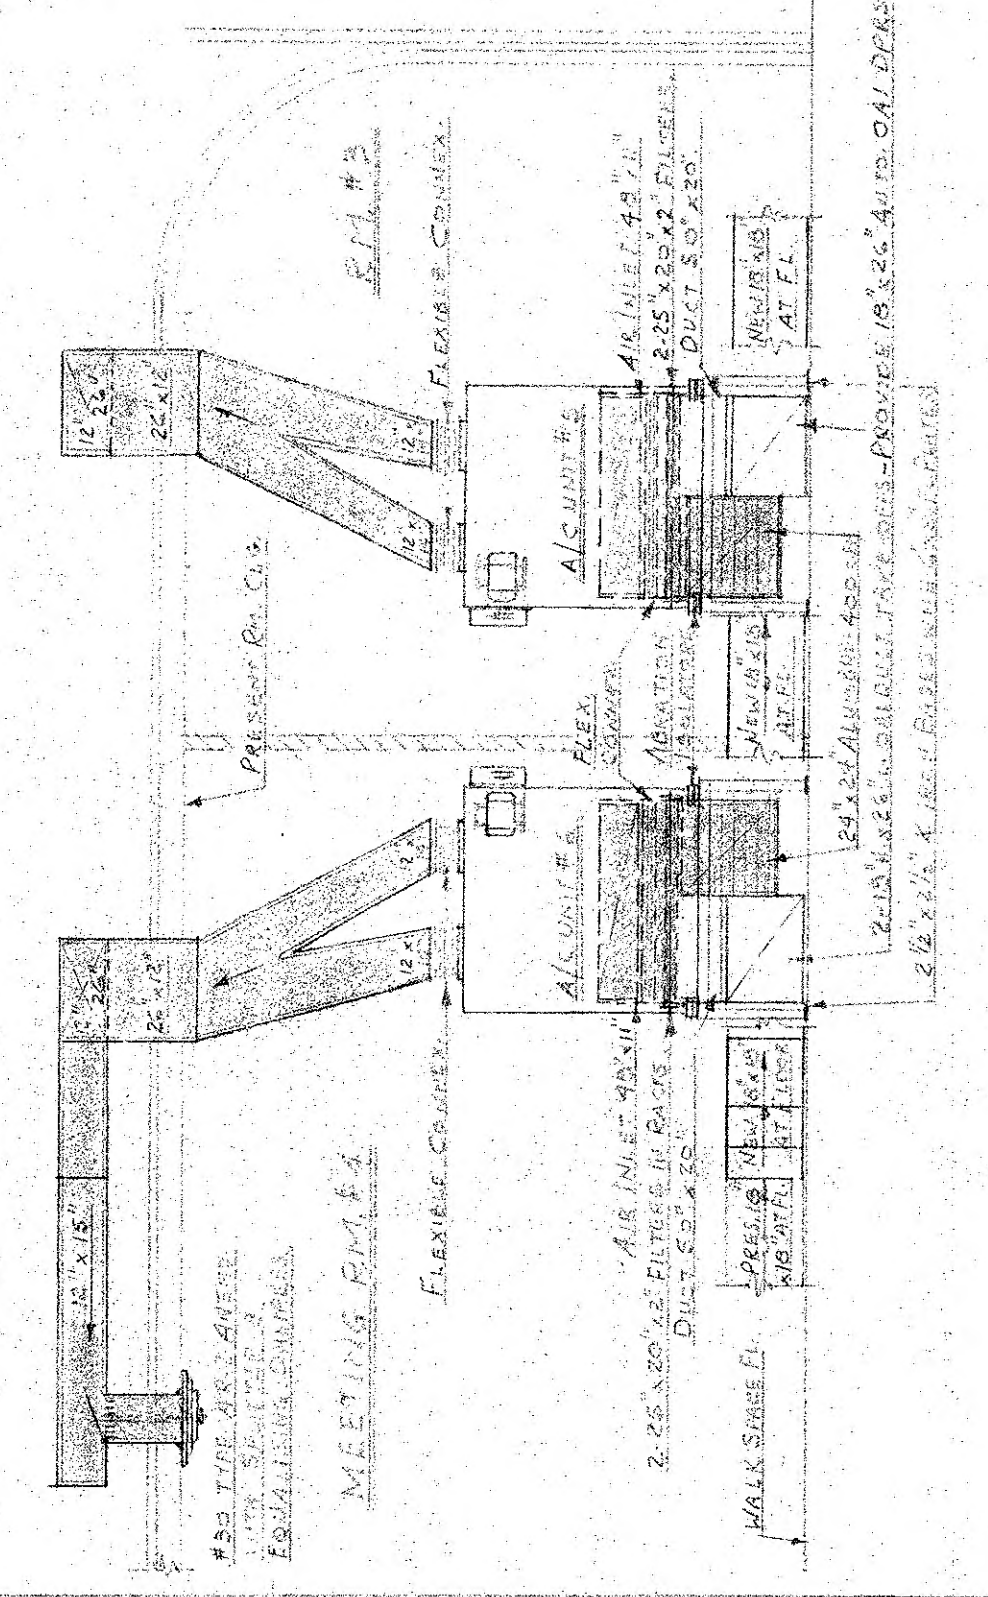

REAR ELEVATION - A/C UNIT #5  
SCALE 1/4" = 1'-0"

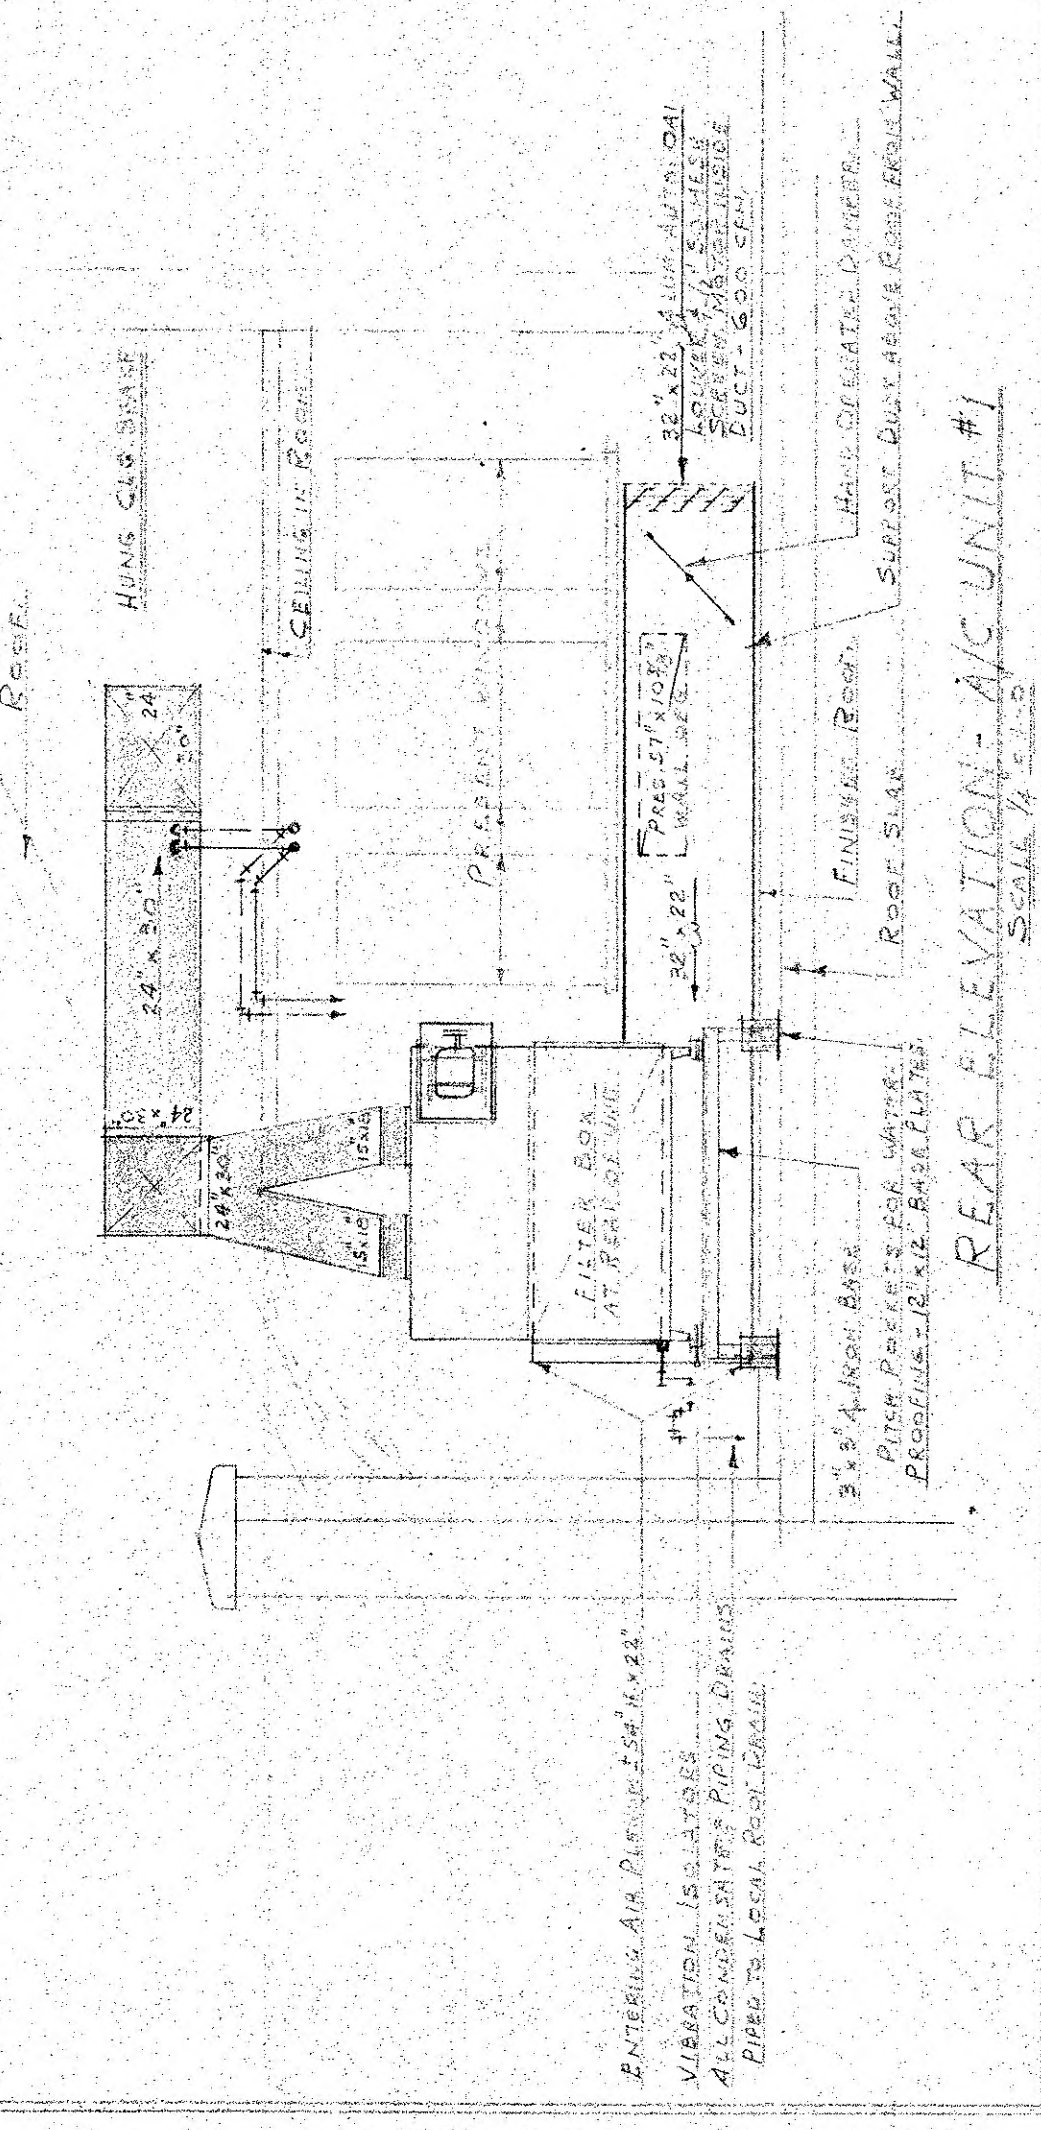

REAR ELEVATION - A/C UNIT #1  
SCALE 1/4" = 1'-0"

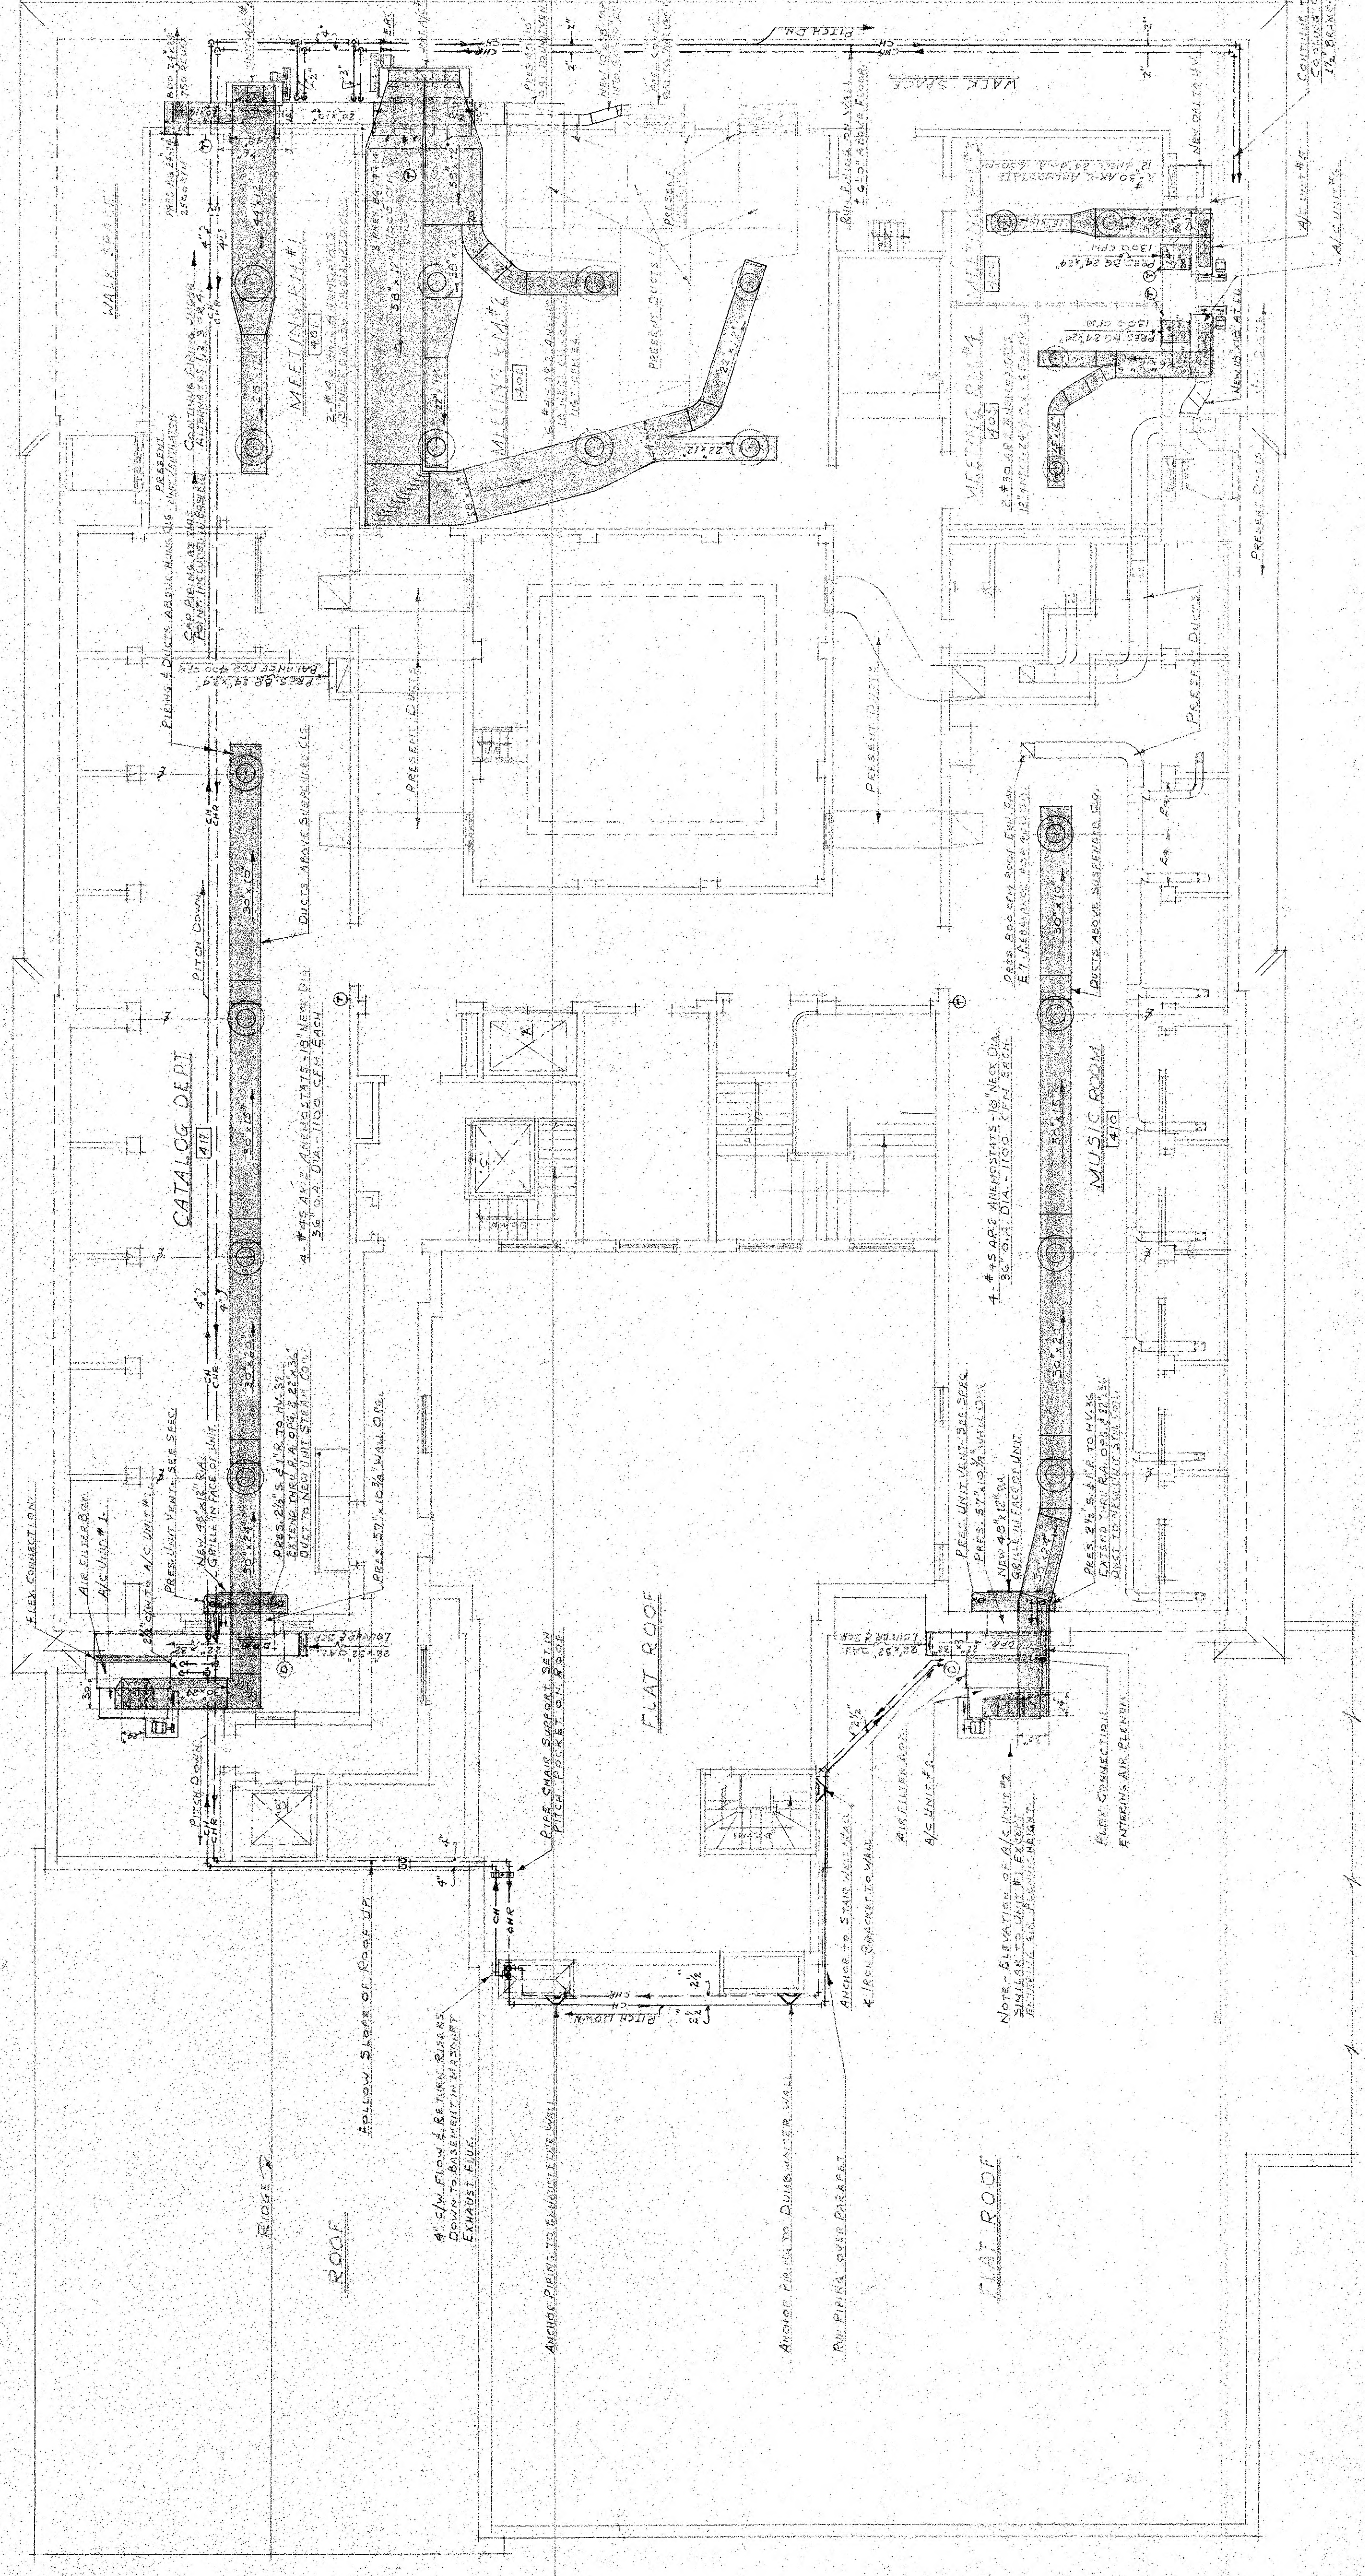

FOURTH FLOOR PLAN  
SCALE 1/8" = 1'-0"


NOTES	SYMBOLS
1. ALL DIMENSIONS SHOWN ON THIS PLAN ARE TO FACE UNLESS OTHERWISE SPECIFIED.	8'-0" 8'-6" 9'-0" 9'-6" 10'-0" 10'-6" 11'-0" 11'-6" 12'-0" 12'-6" 13'-0" 13'-6" 14'-0" 14'-6" 15'-0" 15'-6" 16'-0" 16'-6" 17'-0" 17'-6" 18'-0" 18'-6" 19'-0" 19'-6" 20'-0" 20'-6" 21'-0" 21'-6" 22'-0" 22'-6" 23'-0" 23'-6" 24'-0" 24'-6" 25'-0" 25'-6" 26'-0" 26'-6" 27'-0" 27'-6" 28'-0" 28'-6" 29'-0" 29'-6" 30'-0" 30'-6" 31'-0" 31'-6" 32'-0" 32'-6" 33'-0" 33'-6" 34'-0" 34'-6" 35'-0" 35'-6" 36'-0" 36'-6" 37'-0" 37'-6" 38'-0" 38'-6" 39'-0" 39'-6" 40'-0" 40'-6" 41'-0" 41'-6" 42'-0" 42'-6" 43'-0" 43'-6" 44'-0" 44'-6" 45'-0" 45'-6" 46'-0" 46'-6" 47'-0" 47'-6" 48'-0" 48'-6" 49'-0" 49'-6" 50'-0" 50'-6" 51'-0" 51'-6" 52'-0" 52'-6" 53'-0" 53'-6" 54'-0" 54'-6" 55'-0" 55'-6" 56'-0" 56'-6" 57'-0" 57'-6" 58'-0" 58'-6" 59'-0" 59'-6" 60'-0" 60'-6" 61'-0" 61'-6" 62'-0" 62'-6" 63'-0" 63'-6" 64'-0" 64'-6" 65'-0" 65'-6" 66'-0" 66'-6" 67'-0" 67'-6" 68'-0" 68'-6" 69'-0" 69'-6" 70'-0" 70'-6" 71'-0" 71'-6" 72'-0" 72'-6" 73'-0" 73'-6" 74'-0" 74'-6" 75'-0" 75'-6" 76'-0" 76'-6" 77'-0" 77'-6" 78'-0" 78'-6" 79'-0" 79'-6" 80'-0" 80'-6" 81'-0" 81'-6" 82'-0" 82'-6" 83'-0" 83'-6" 84'-0" 84'-6" 85'-0" 85'-6" 86'-0" 86'-6" 87'-0" 87'-6" 88'-0" 88'-6" 89'-0" 89'-6" 90'-0" 90'-6" 91'-0" 91'-6" 92'-0" 92'-6" 93'-0" 93'-6" 94'-0" 94'-6" 95'-0" 95'-6" 96'-0" 96'-6" 97'-0" 97'-6" 98'-0" 98'-6" 99'-0" 99'-6" 100'-0" 100'-6"

679	AC-2	FOX & TAYLOR CONSULTING ENGINEERS 512 ORANGE STREET NEWARK 7, N.J.
REVISIONS - AIR CONDITIONING - FOURTH FLOOR PLAN - ALTERATIONS TO MAIN BLOG - THE FREE PUBLIC LIBRARY		
DRAWN BY: SCALE: 1/8" = 1'-0" DATE: 6-22-53 WASHINGTON ST. NEWARK, N.J.		
CHECKED BY: SEAMAN 301 BROAD STREET, NEWARK 2, N.J.		







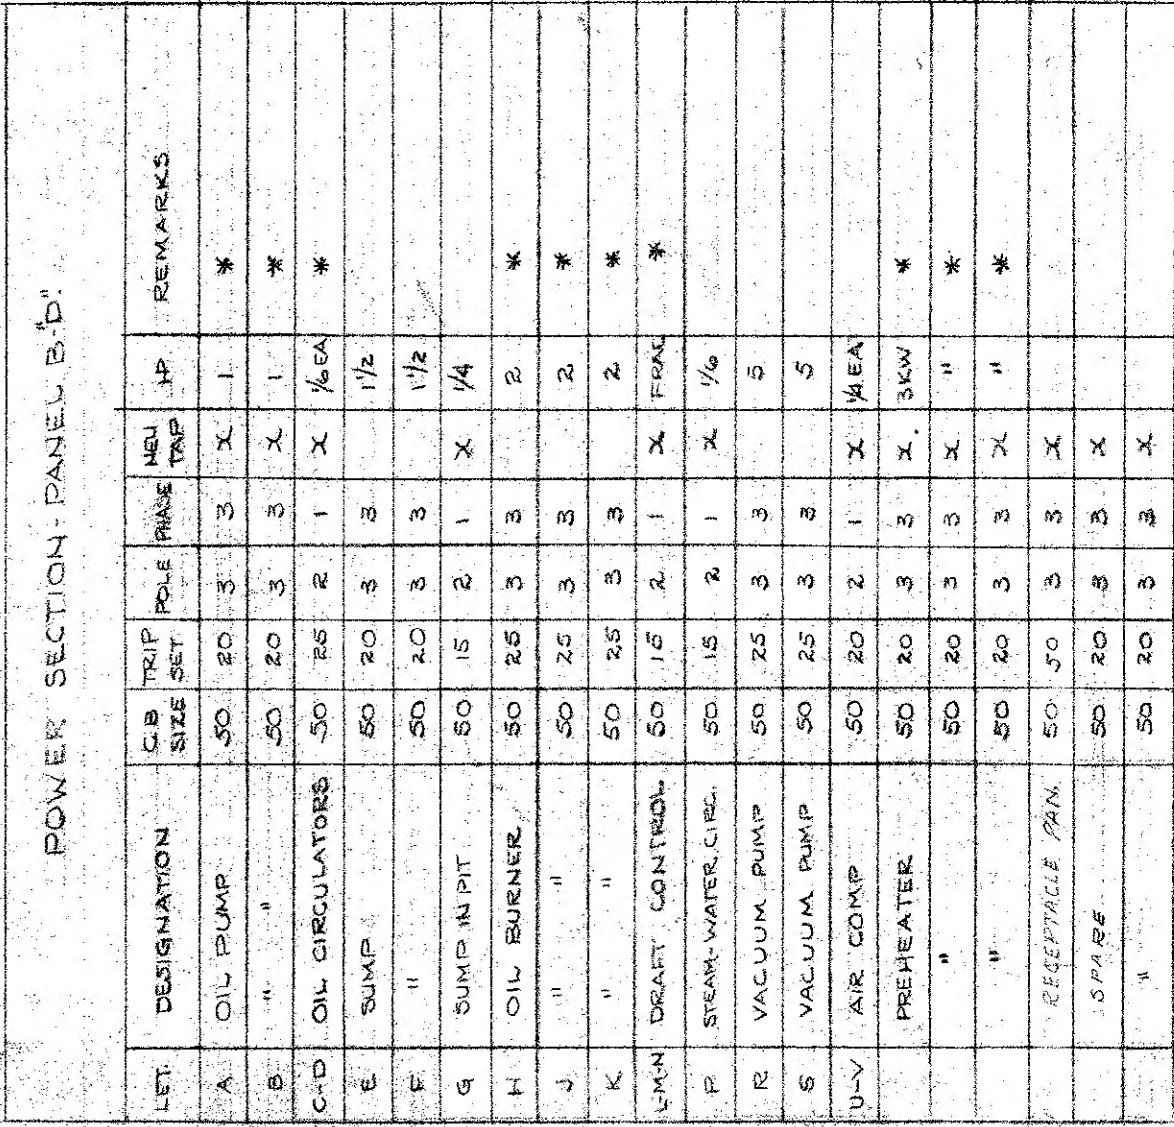

△-△ 30A-220V 3P GROUNDING RECEPT.

\* ALSO BULLETIN 01-35-15A SWITCH AHEAD OF THESE BRANCHES FOR LIGHTING BRANCHES SEE DRAWING E-11

NOTE  
RUN ALLOWING EXPOSED CARTRIDGE EXCEPT  
MAIN FEEDERS BEGINS OTHERWISE NOTED

12  
100 ASG #E SUPPLY  
11-4" CONDUITS. ALL CONDUITS AND WIRE BY P.S.G.#E-CC





EX-16 TING SEWEE

SECRET

△ TRANSFORMER VAULT RELOCATED.  
MAIN SWITCHGEAR RELOCATED  
FEEDER THROUGH LAUNCH CHANGED  
RELOCATION OF EQUIPMENT IN OLD  
SWITCHBOARD ROOM.  
RELOCATED TELEPHONE CABINET IN  
ADJACENT MECHANICAL RECEPTIONS IN  
SPACE 4 & 5.  
ADDED PANEL 4 FEEDER IN SPACE  
ADDED FEEDER FOR BUYDOWN WATER  
ALTERED SITE RELOCATION OF PULL  
REMOVED CONDUITS

ELECTRICAL  
BASMENT FLOOR POWER  
ALTERATIONS TO MAIN BLDG.  
FOR  
THE FREE PUBLIC LIBRARY  
WASHINGTON  
NEWARK N.J.  
DRAWN BY EED SCALE 1/8" = 1'-0" DATE APR. 1961  
EPPLE & SEAMAN  
ARCHITECTS & ENGINEERS  
901 BRADDOCK STREET  
NEWARK N.J.



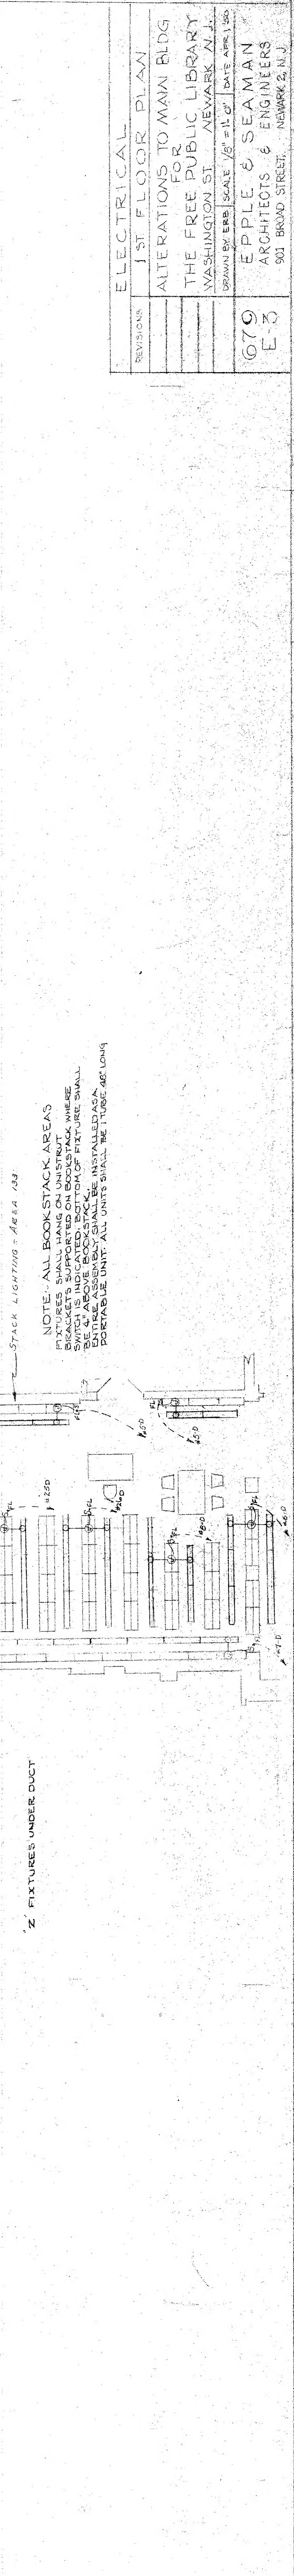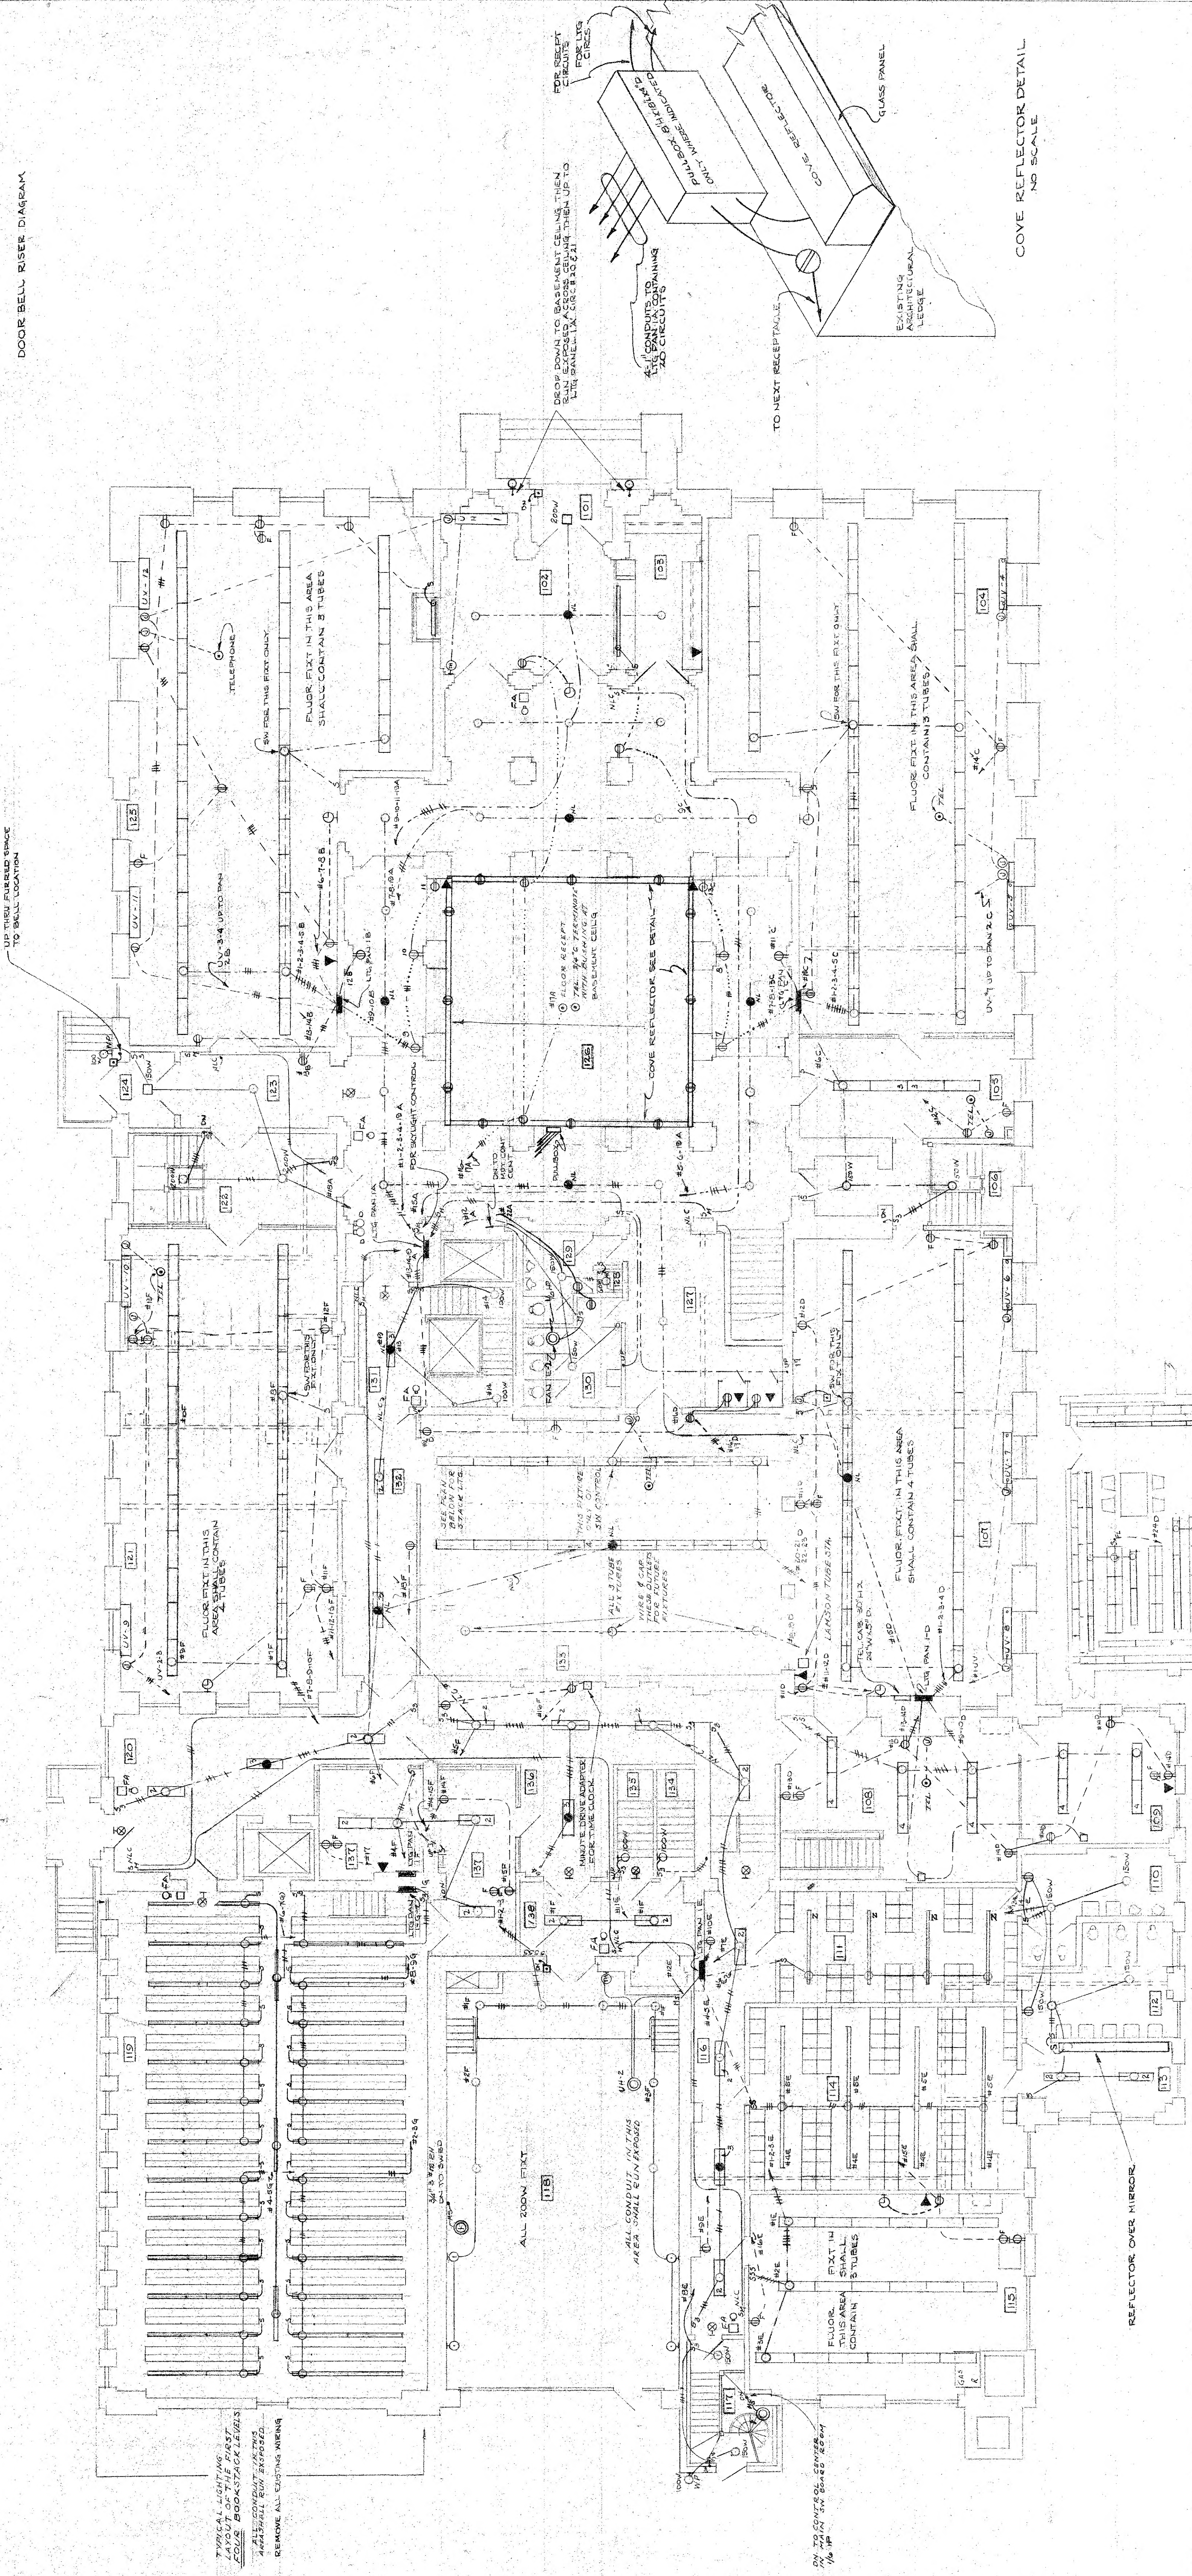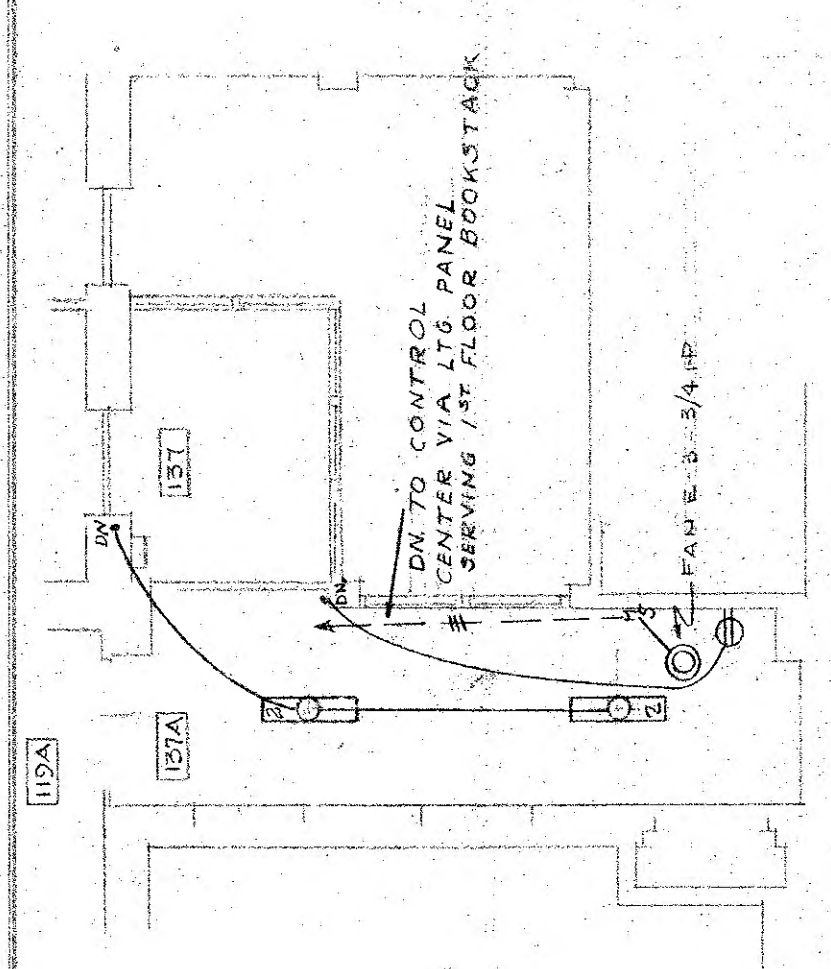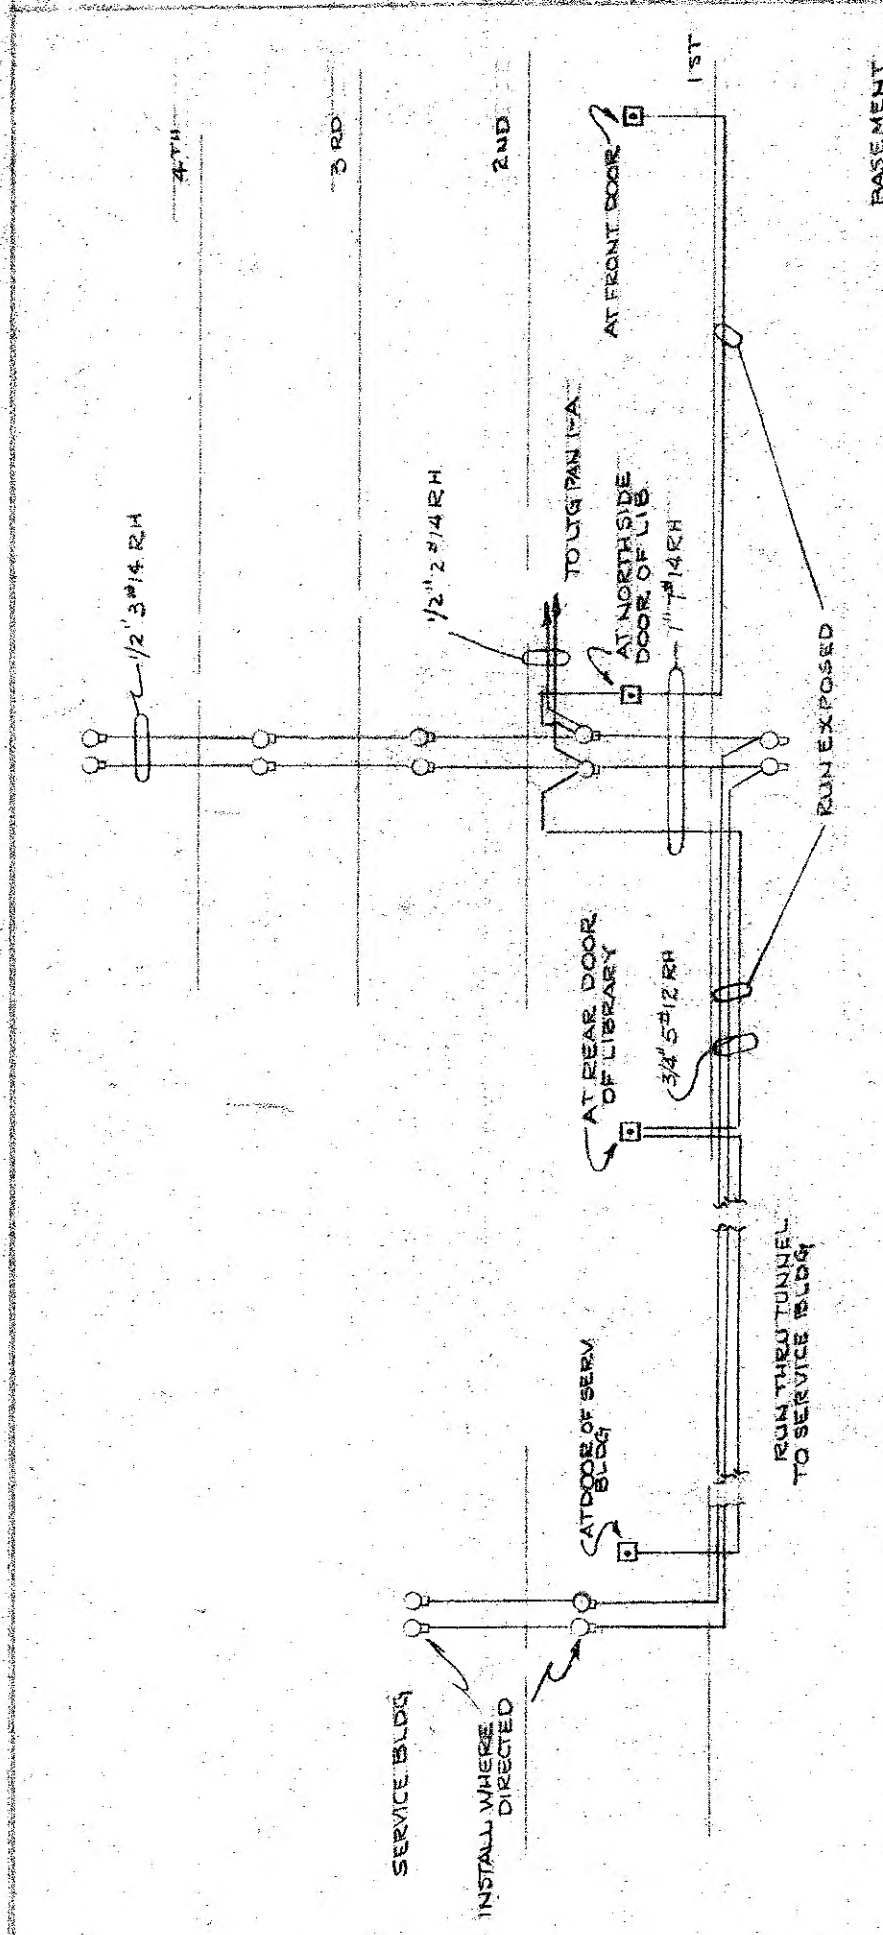

REVISIONS	DESCRIPTION
1	ALTERATIONS TO MAIN BLDG
2	THE FREE PUBLIC LIBRARY
3	WASHINGTON ST. NEWARK, N.J.
4	DATE APR 1 1955
5	SCALE 1/8" = 1'-0"
6	679
7	E-3
8	EPPLER & SEAMAN
9	ARCHITECTS & ENGINEERS
10	901 BROAD STREET, NEWARK, N.J.


NOTE: ALL BOOKSTACK AREAS  
SHALL BE ILLUMINATED BY  
FLUORESCENT LIGHTING  
SUSPENDED FROM THE  
CEILING. SWITCHES SHALL  
BE LOCATED AT THE  
BOTTOM OF EACH BOOKSTACK  
UNIT. ALL UNITS SHALL BE  
TUBES 48" LONG

'Z' FIXTURES UNDER DUCT

REFLECTOR OVER MIRROR


TYPICAL LIGHTING  
FIXTURES  
FOR BOOKSTACK AREAS  
SHALL BE ILLUMINATED  
BY FLUORESCENT LIGHTING  
SUSPENDED FROM THE  
CEILING. SWITCHES SHALL  
BE LOCATED AT THE  
BOTTOM OF EACH BOOKSTACK  
UNIT. ALL UNITS SHALL BE  
TUBES 48" LONG



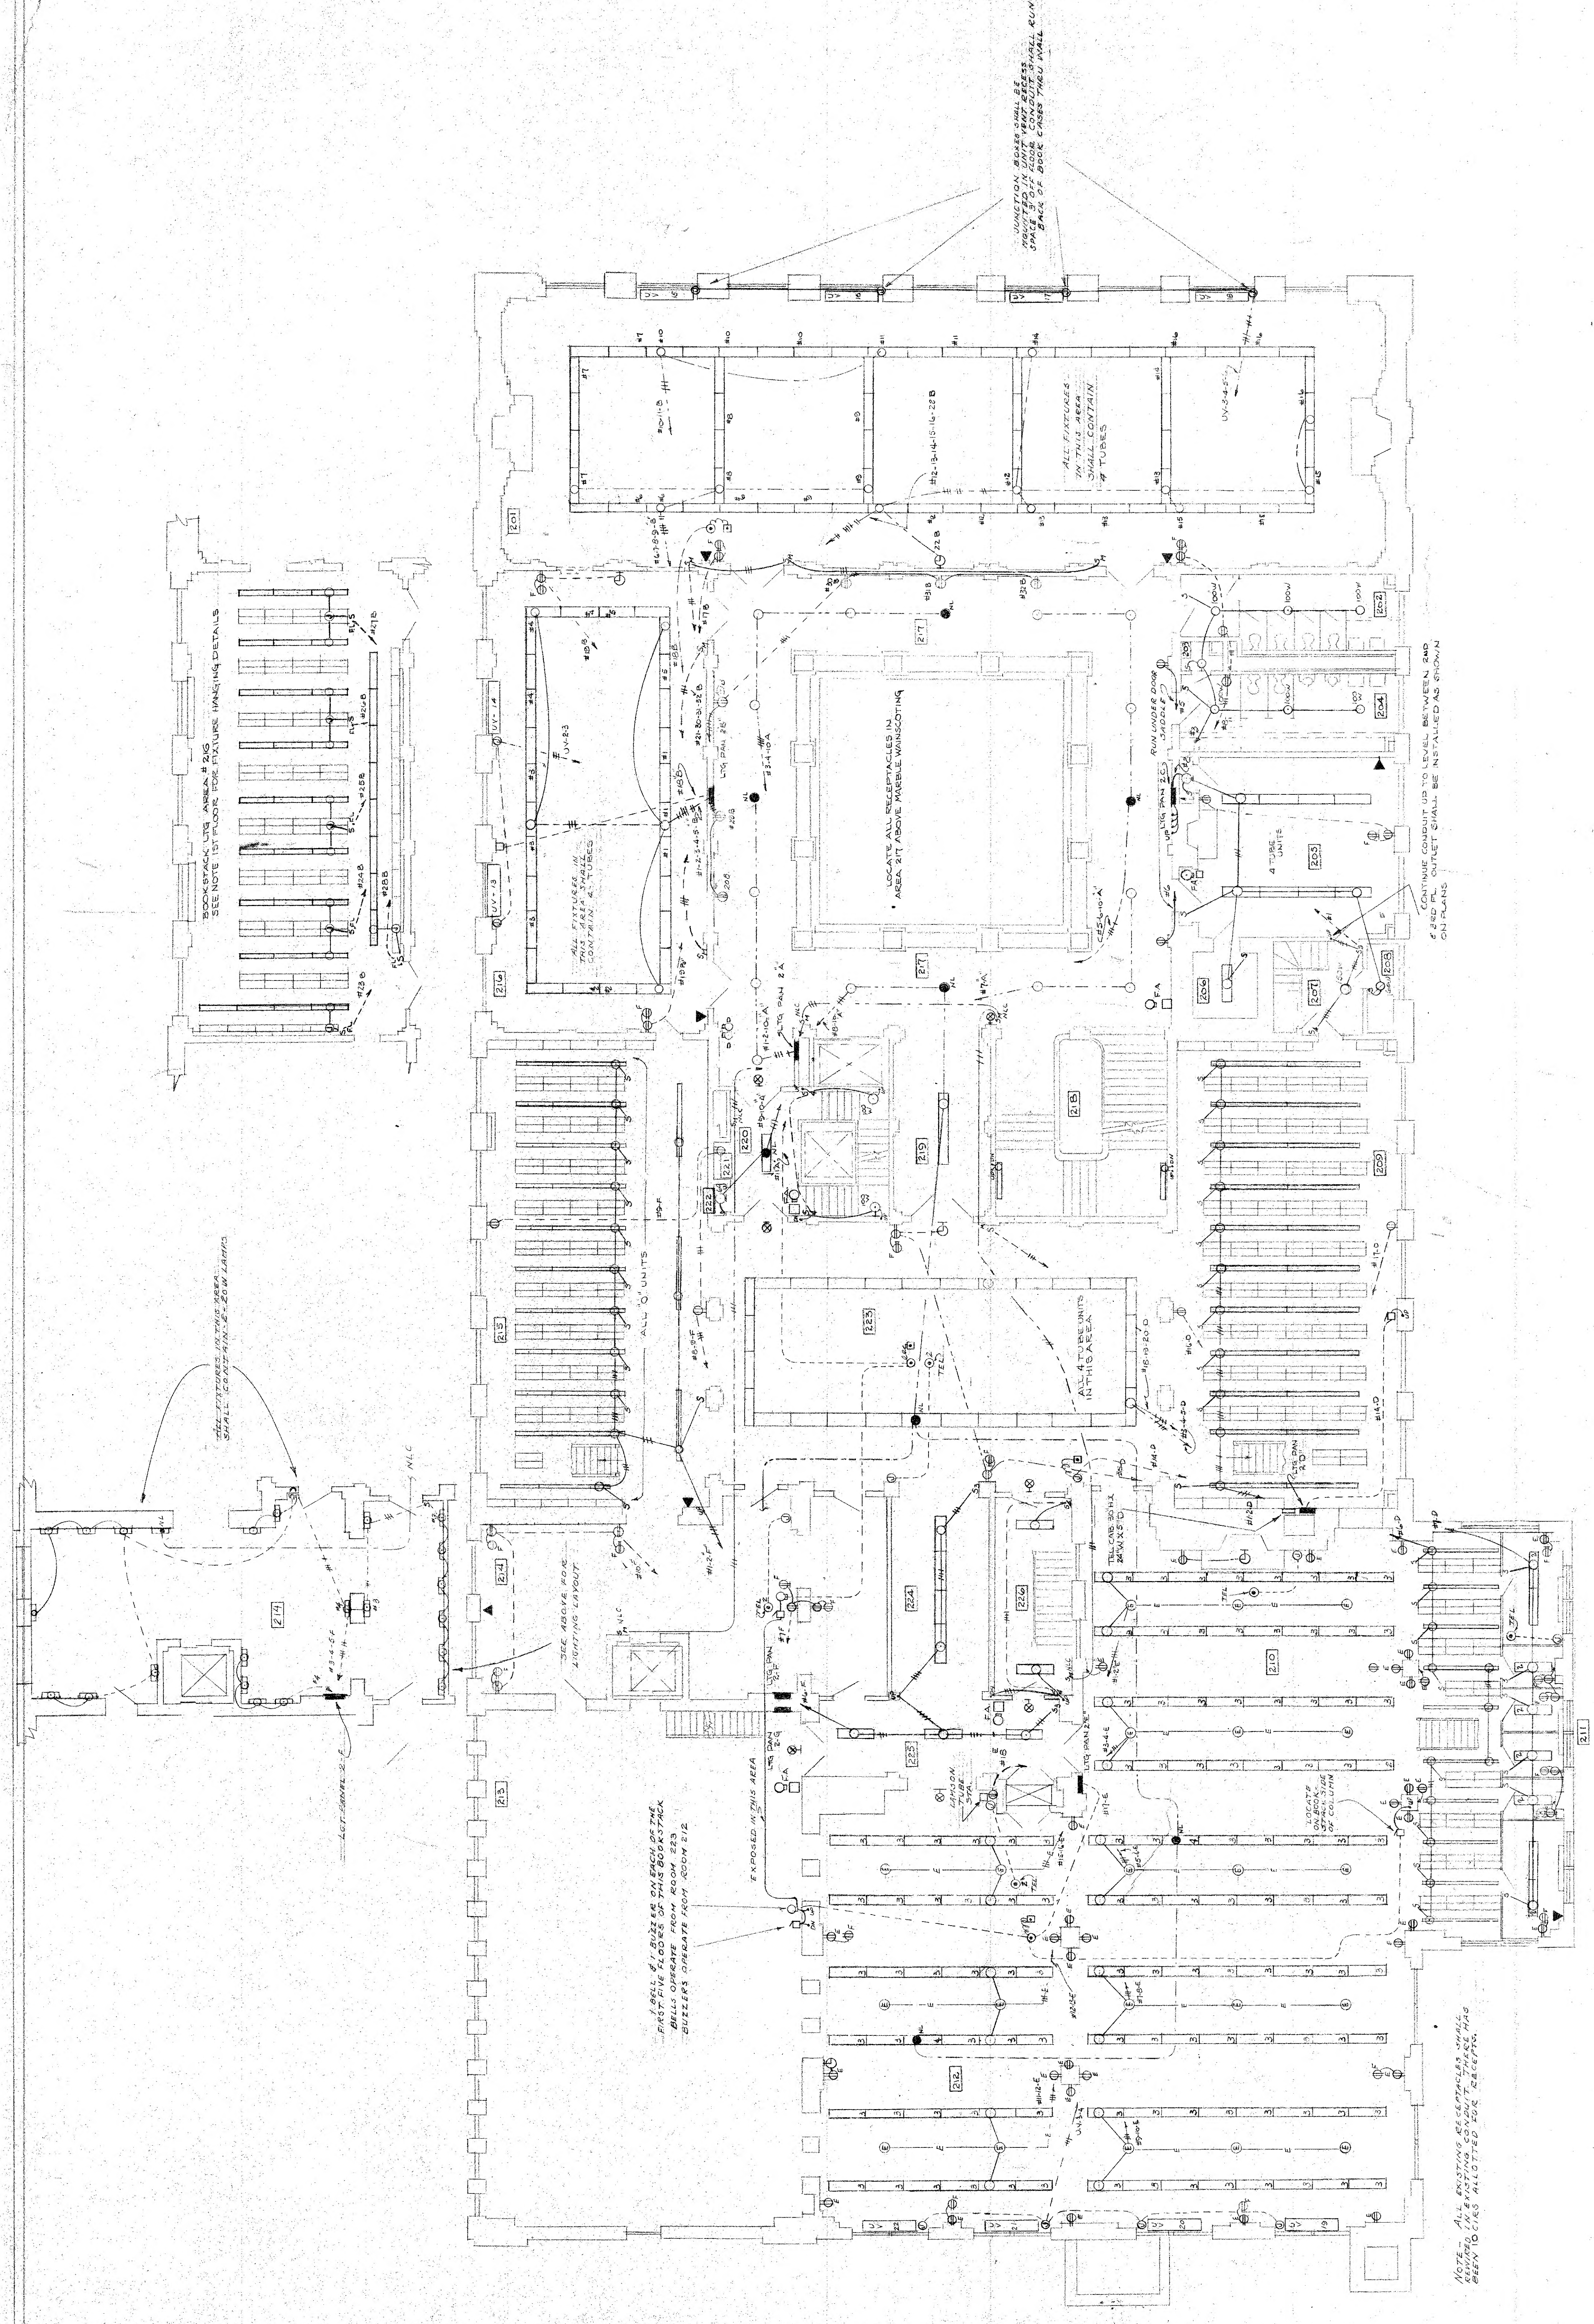



ELECTRICAL	
REVISIONS	2ND FLOOR PLAN
ALTERATIONS TO MAIN BLDG	
FOR	
THE FREE PUBLIC LIBRARY	
WASHINGTON ST. NEWARK, N.J.	
679	DATE APR. 1930
E-4	EPPLER & SEAMAN
	ARCHITECTS & ENGINEERS
	901 BROAD STREET, NEWARK, N.J.



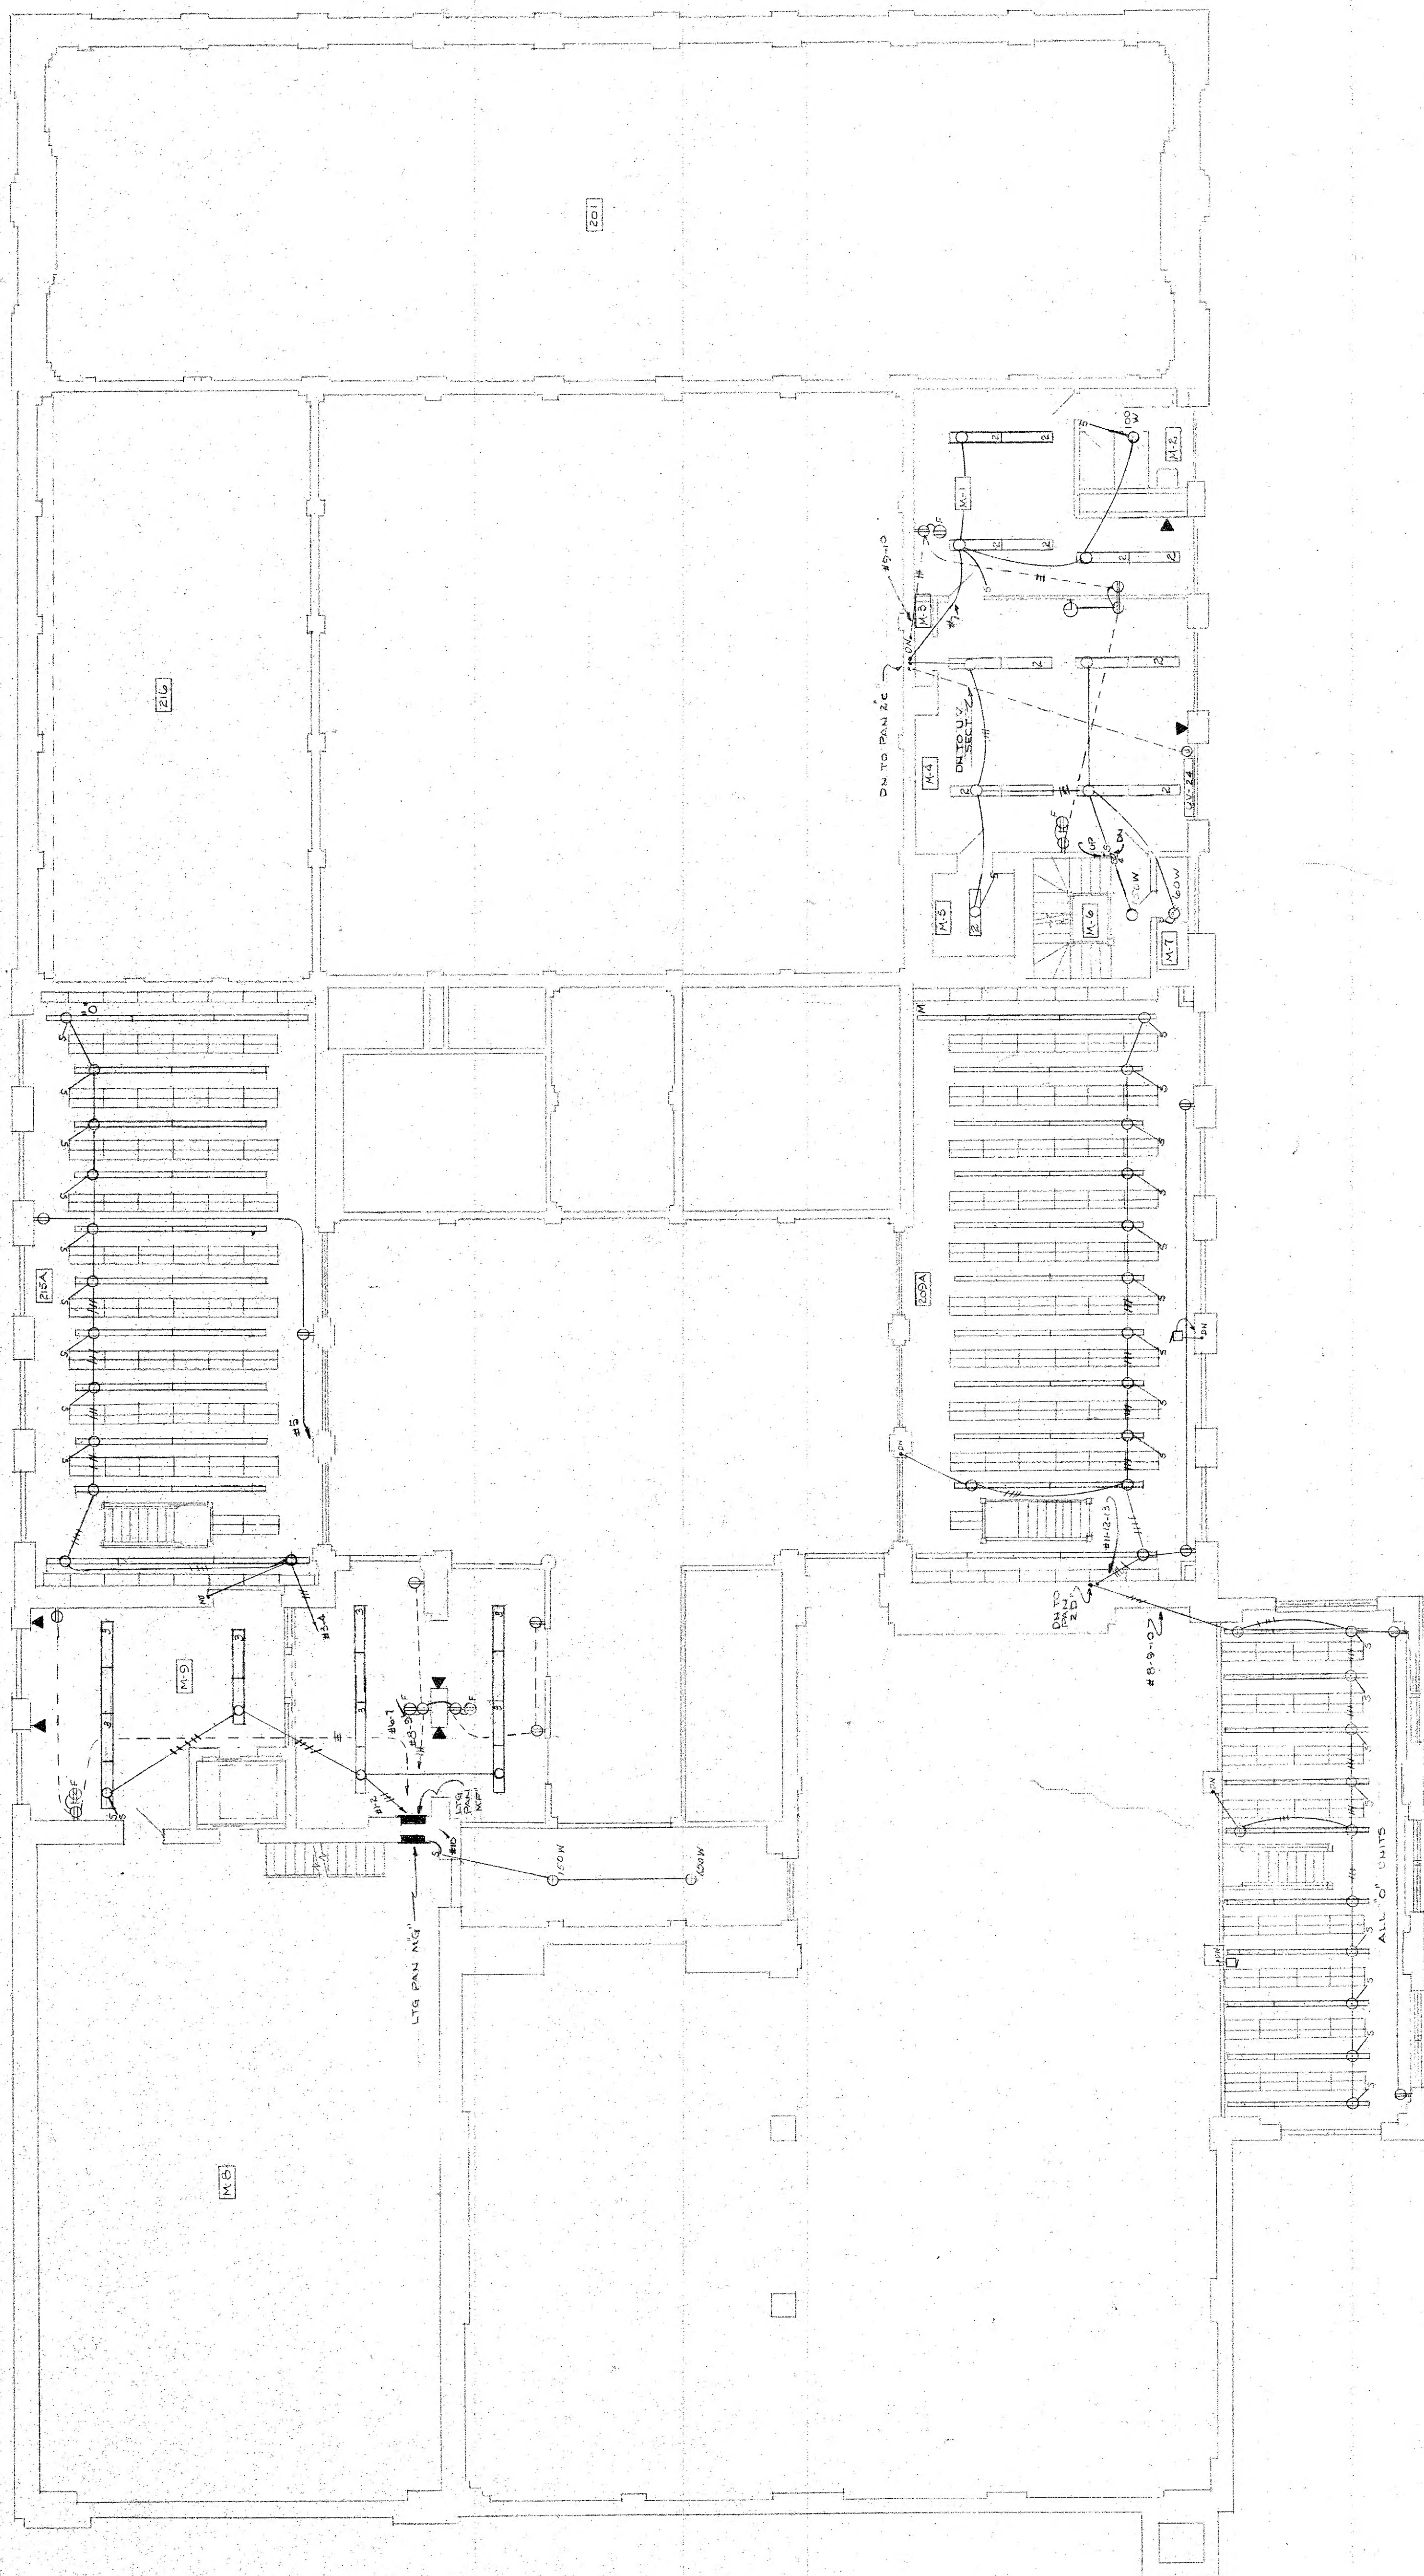


679  
E-5  
ELECTRICAL  
MEZZANINE BET. 2ND & 3RD FLOOR  
ALTERATIONS TO MAIN BLDG  
FOR  
THE FREE PUBLIC LIBRARY  
WASHINGTON ST. NEWARK, N.J.  
DRAWN BY EBBE SCALE 1/8" = 1'-0" DATE APRIL 1950  
EPPLE & SEAMAN  
ARCHITECTS & ENGINEERS  
901 BROAD STREET, NEWARK, N. J.



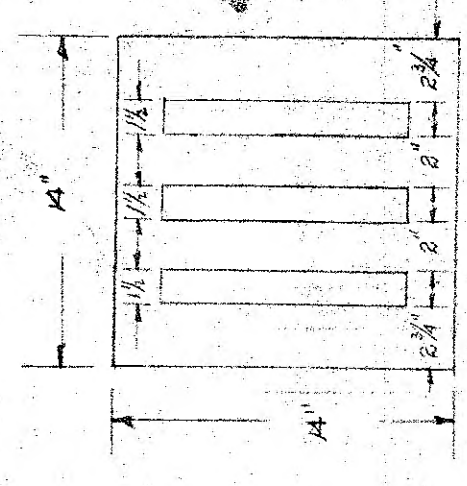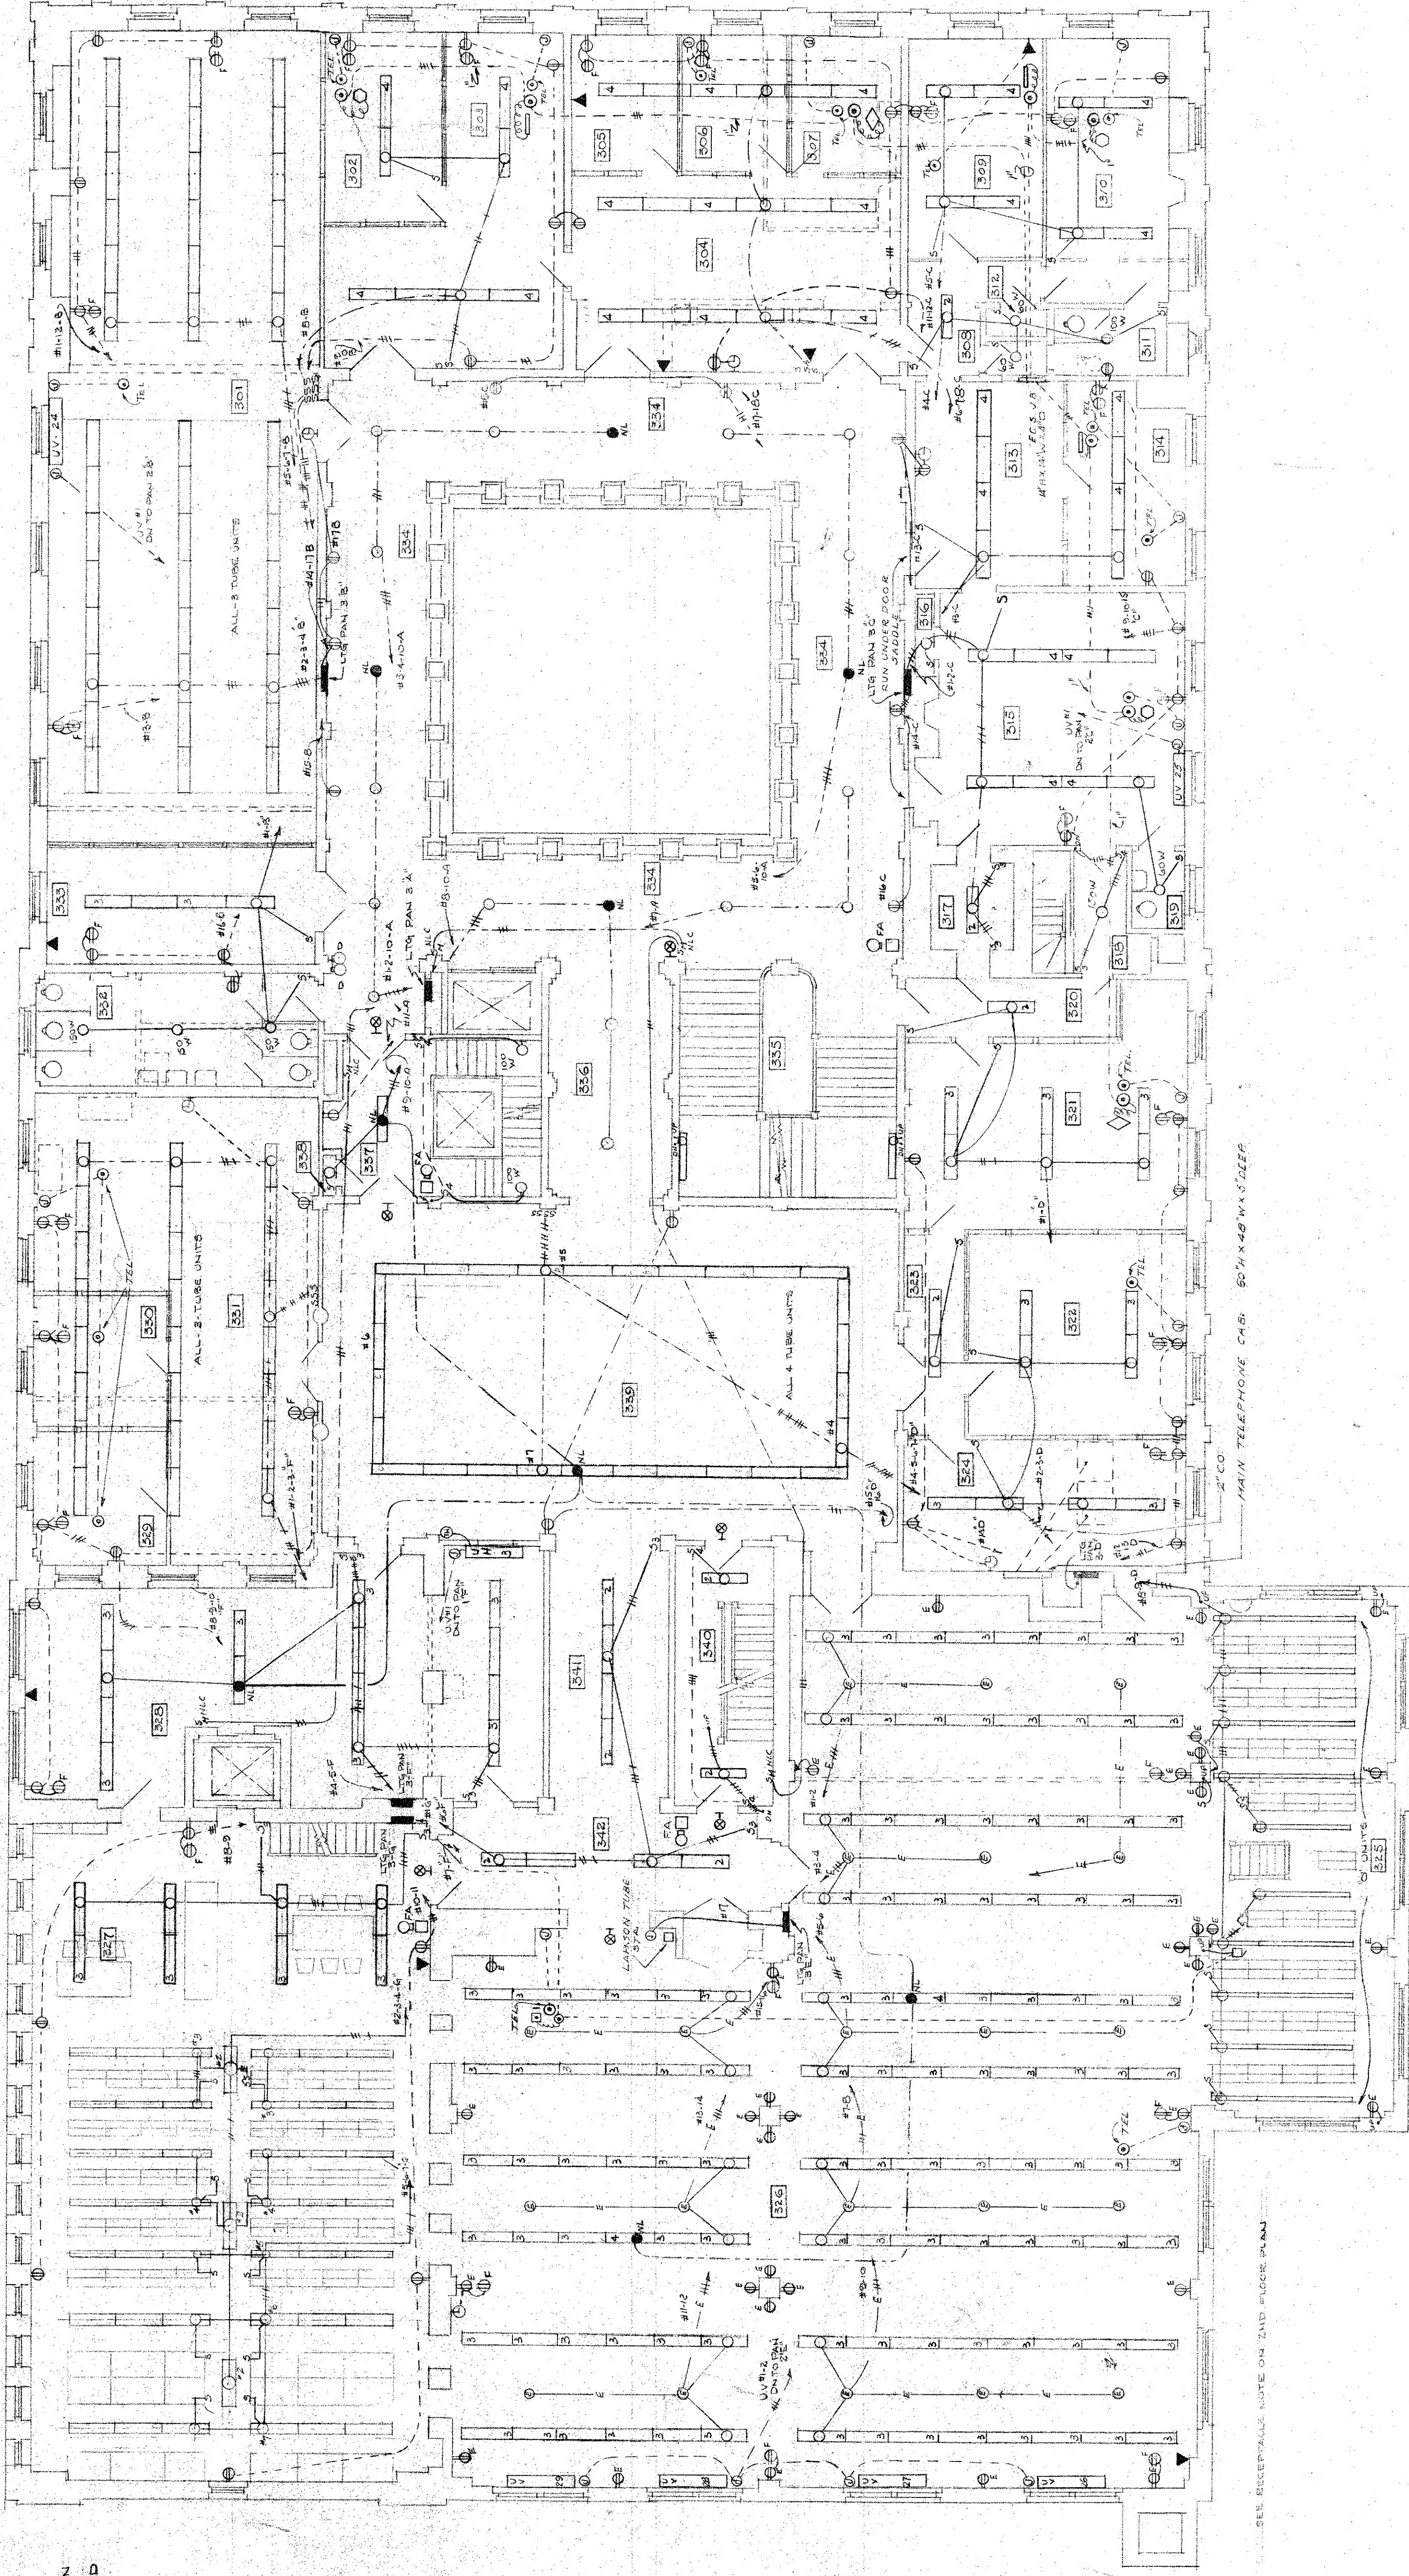


DETAIL OF E.C.B. JUNCTION BOX FOR E.C.B. LINES TO TERMINATE AT THE MAIN BLOCK RUN TO STATION FROM THE MAIN BLOCK. SCALE 1/8"

--- AS INDICATED ON EXECUTIVE SYSTEM CONDUITS  
--- SHALL MEAN 3/4\"/>

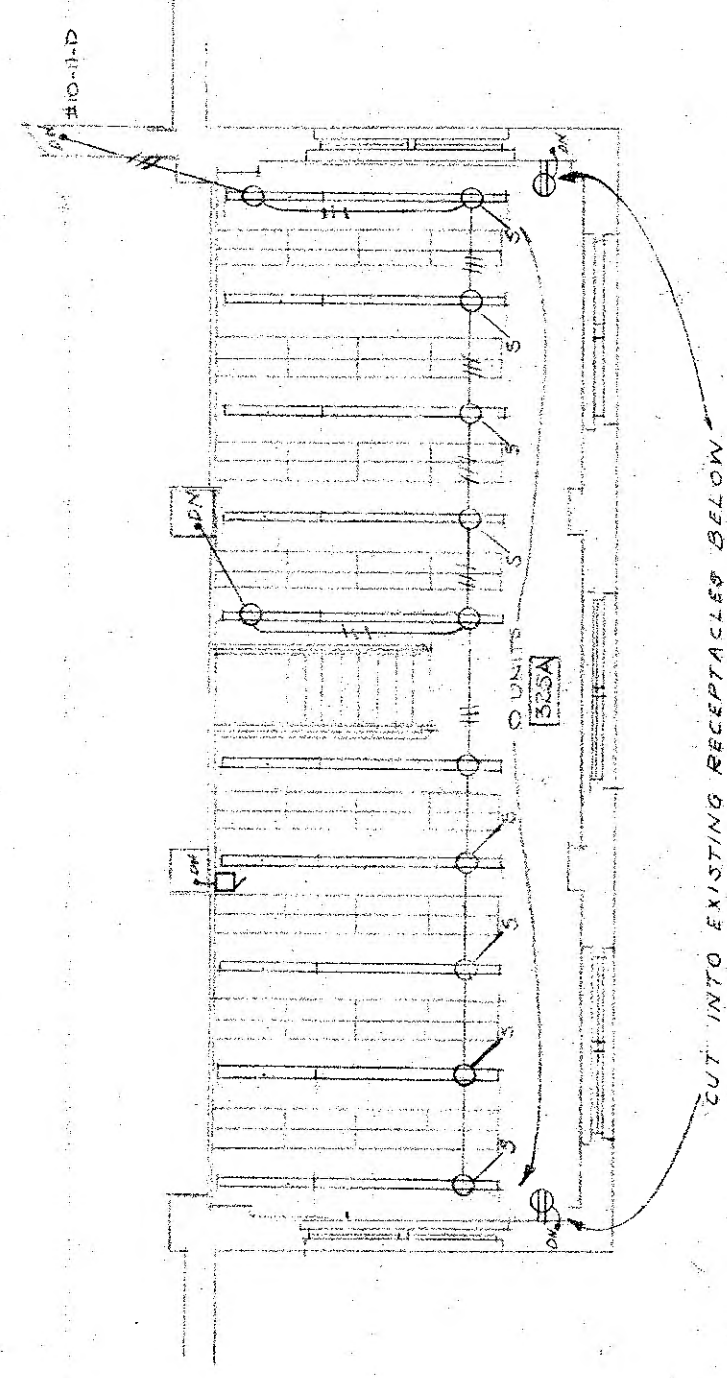

ELECTRICAL	
3RD FLOOR PLAN	
ALTERATIONS TO MAIN BLDG	
FOR	
THE FREE PUBLIC LIBRARY	
WASHINGTON ST. NEWARK, N.J.	
DRAWN BY: E.C.B.	SCALE: 1/8" = 1'-0"
DATE: 1/20/50	
679	E-6
APPLE & SEAMAN	
ARCHITECTS & ENGINEERS	
901 BROAD STREET, NEWARK 2, N.J.	



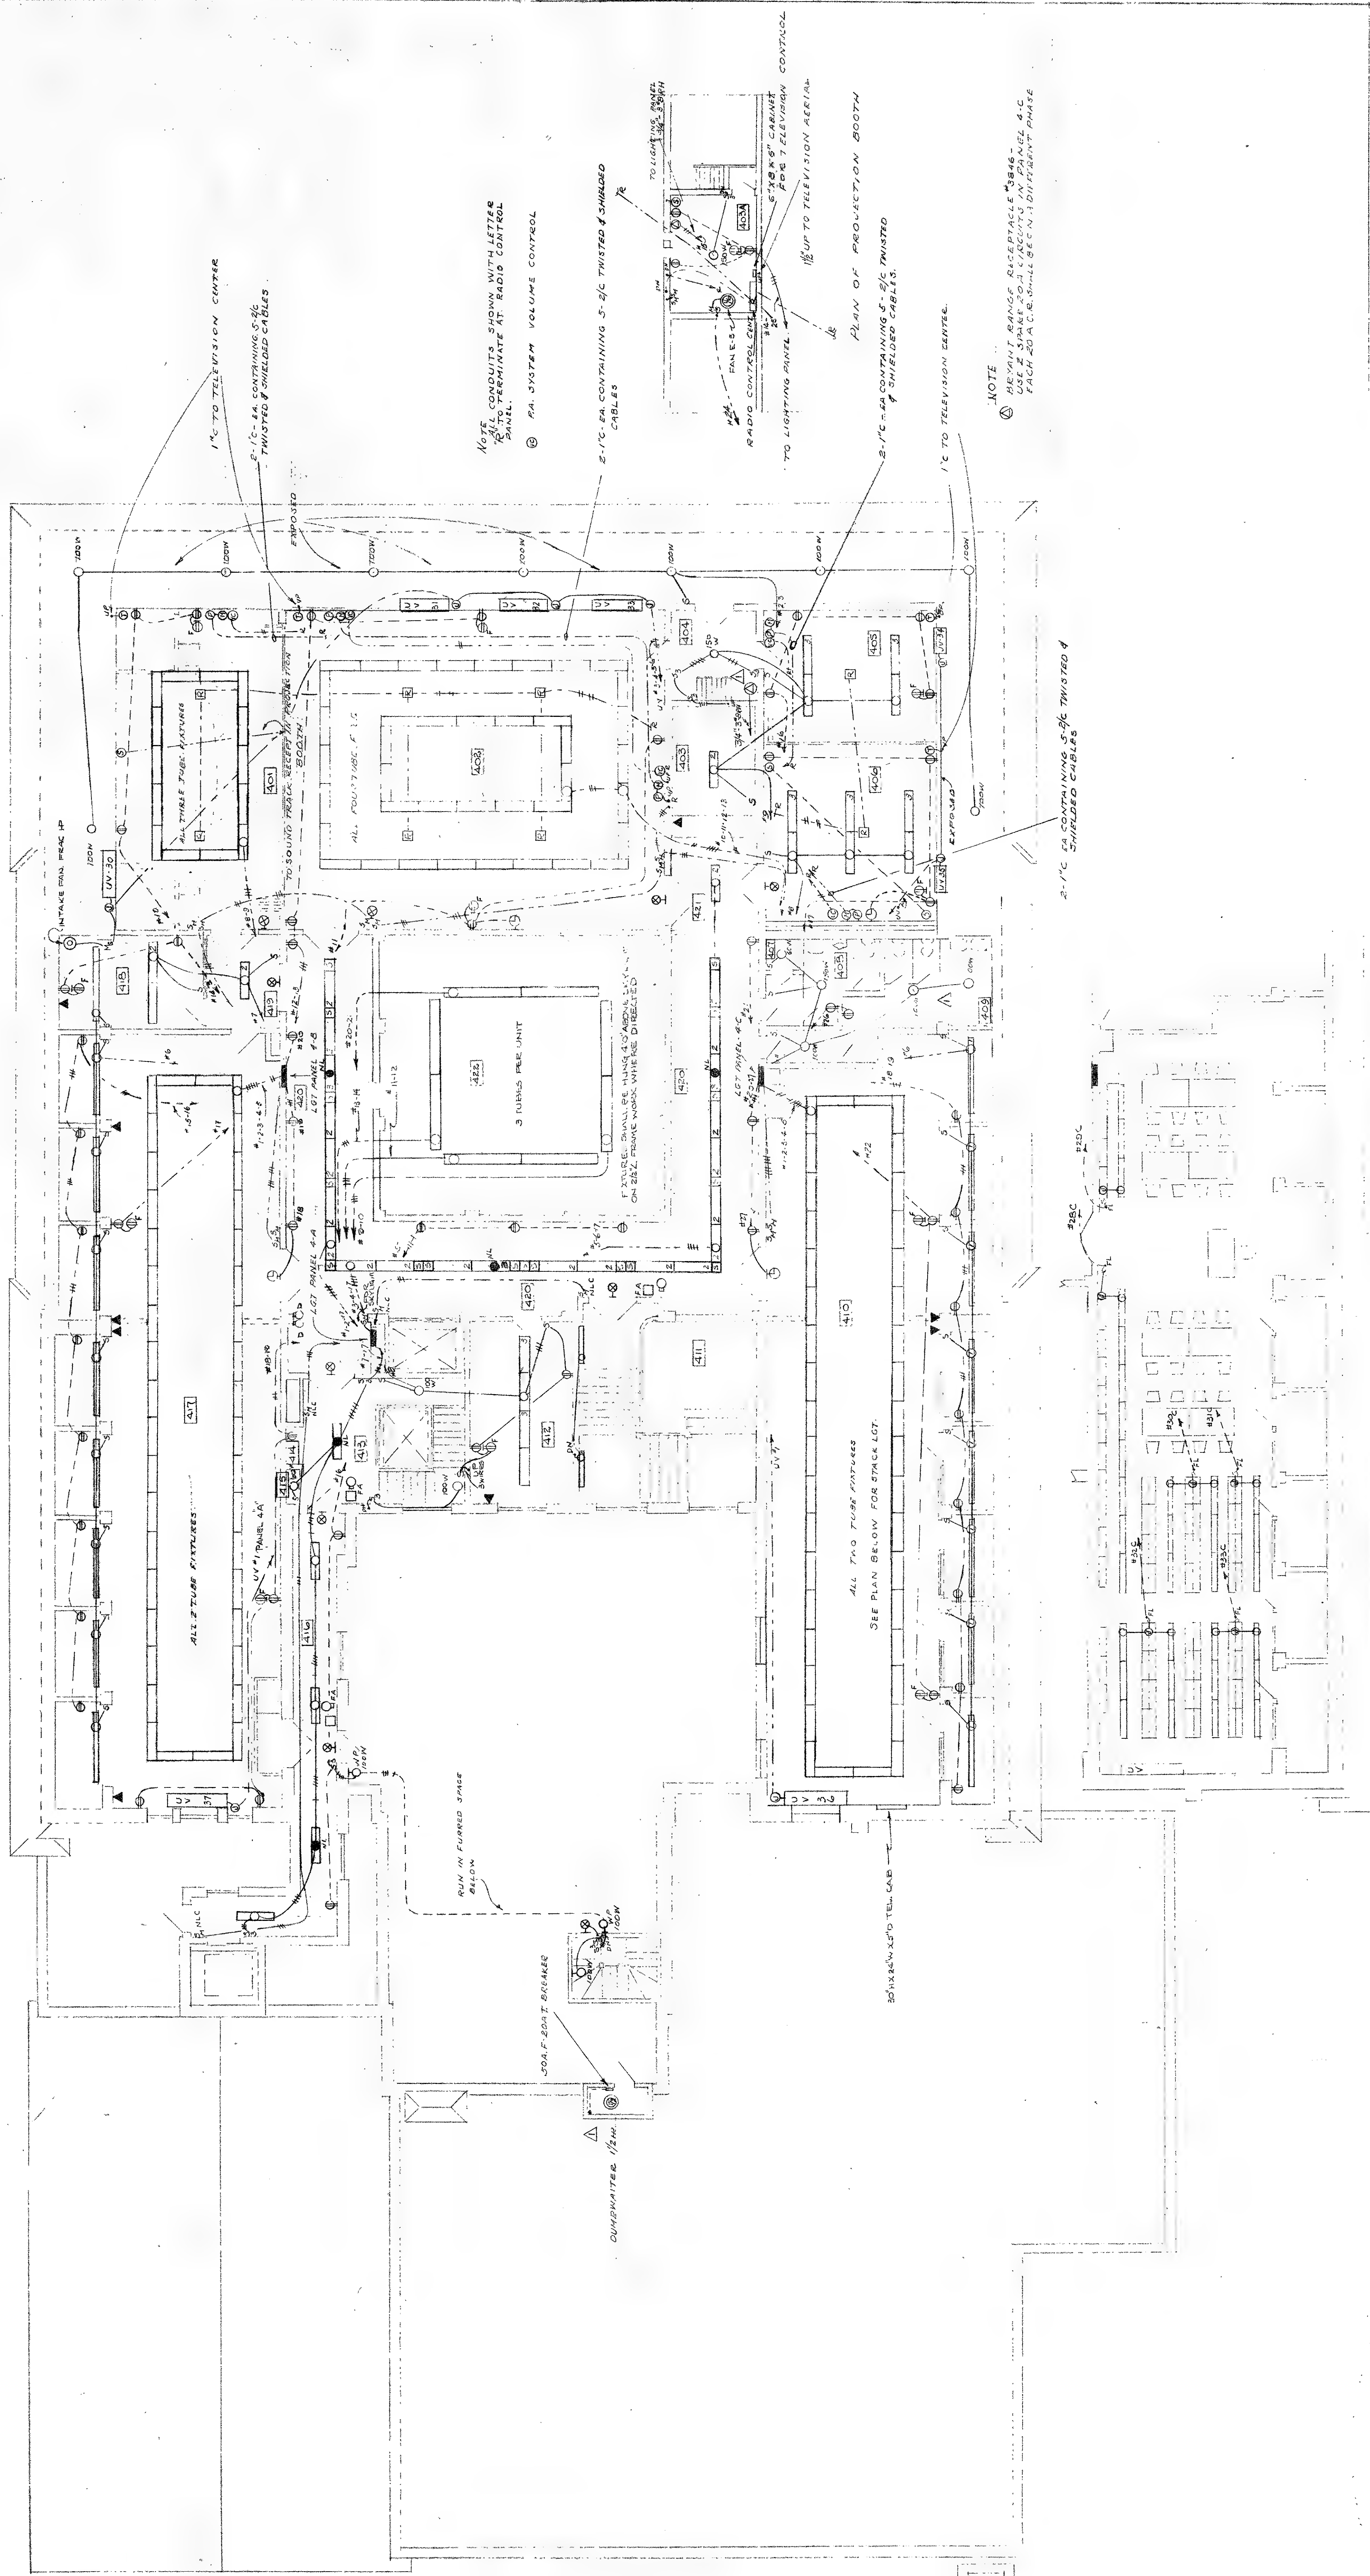

ELECTRICAL	
REVISIONS	4TH FLOOR PLAN
Δ 9/1/50	ALTERATIONS TO MAIN BLDG FOR THE FREE PUBLIC LIBRARY
WASHINGTON ST.	NEWARK, N.J.
DRAWN BY	SCALE 1/8" = 1'-0"
DATE	APR 1 1950
679	APPLE & SEAMAN
E-7	ARCHITECTS & ENGINEERS
	901 BROAD STREET, NEWARK, N.J.

HEAVY DUTY ELECTRICAL FOR 4 BURNERS 300V ADDL. SEE NOTE CHANGED POSITION OF LIGHT CHANGES IN ROOMS. ADDED SHIMMER WATER TIGHT JOINTS.

BOOK STACK LITG. AREA 410 SEE NOTE 1ST FLOOR FOR PICTURE HANGING DETAILS

RUN IN FURRED SPACE BELOW

500 F. 200 T. BREAKER

OVERWATER 1/2 IN.

501 X 2 IN. 250 TEL. CAB.

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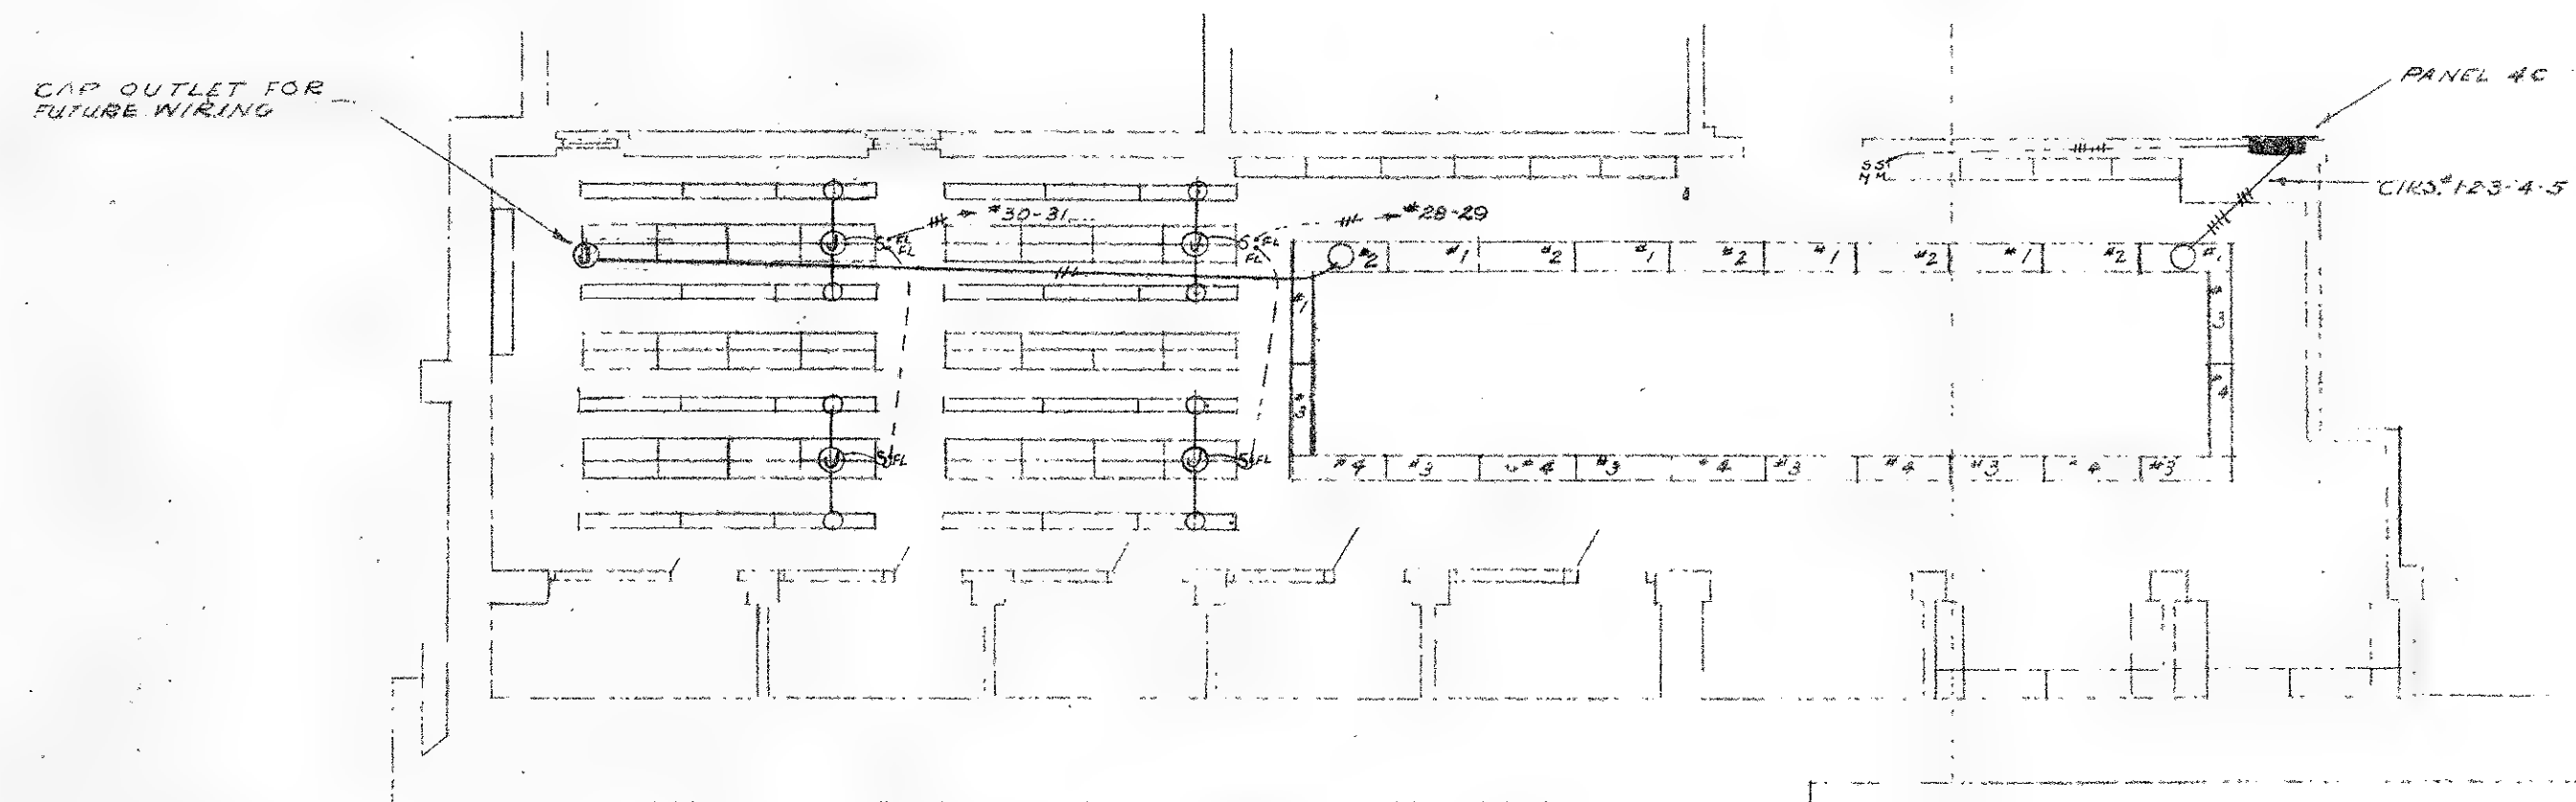
TO LIGHTING PANEL

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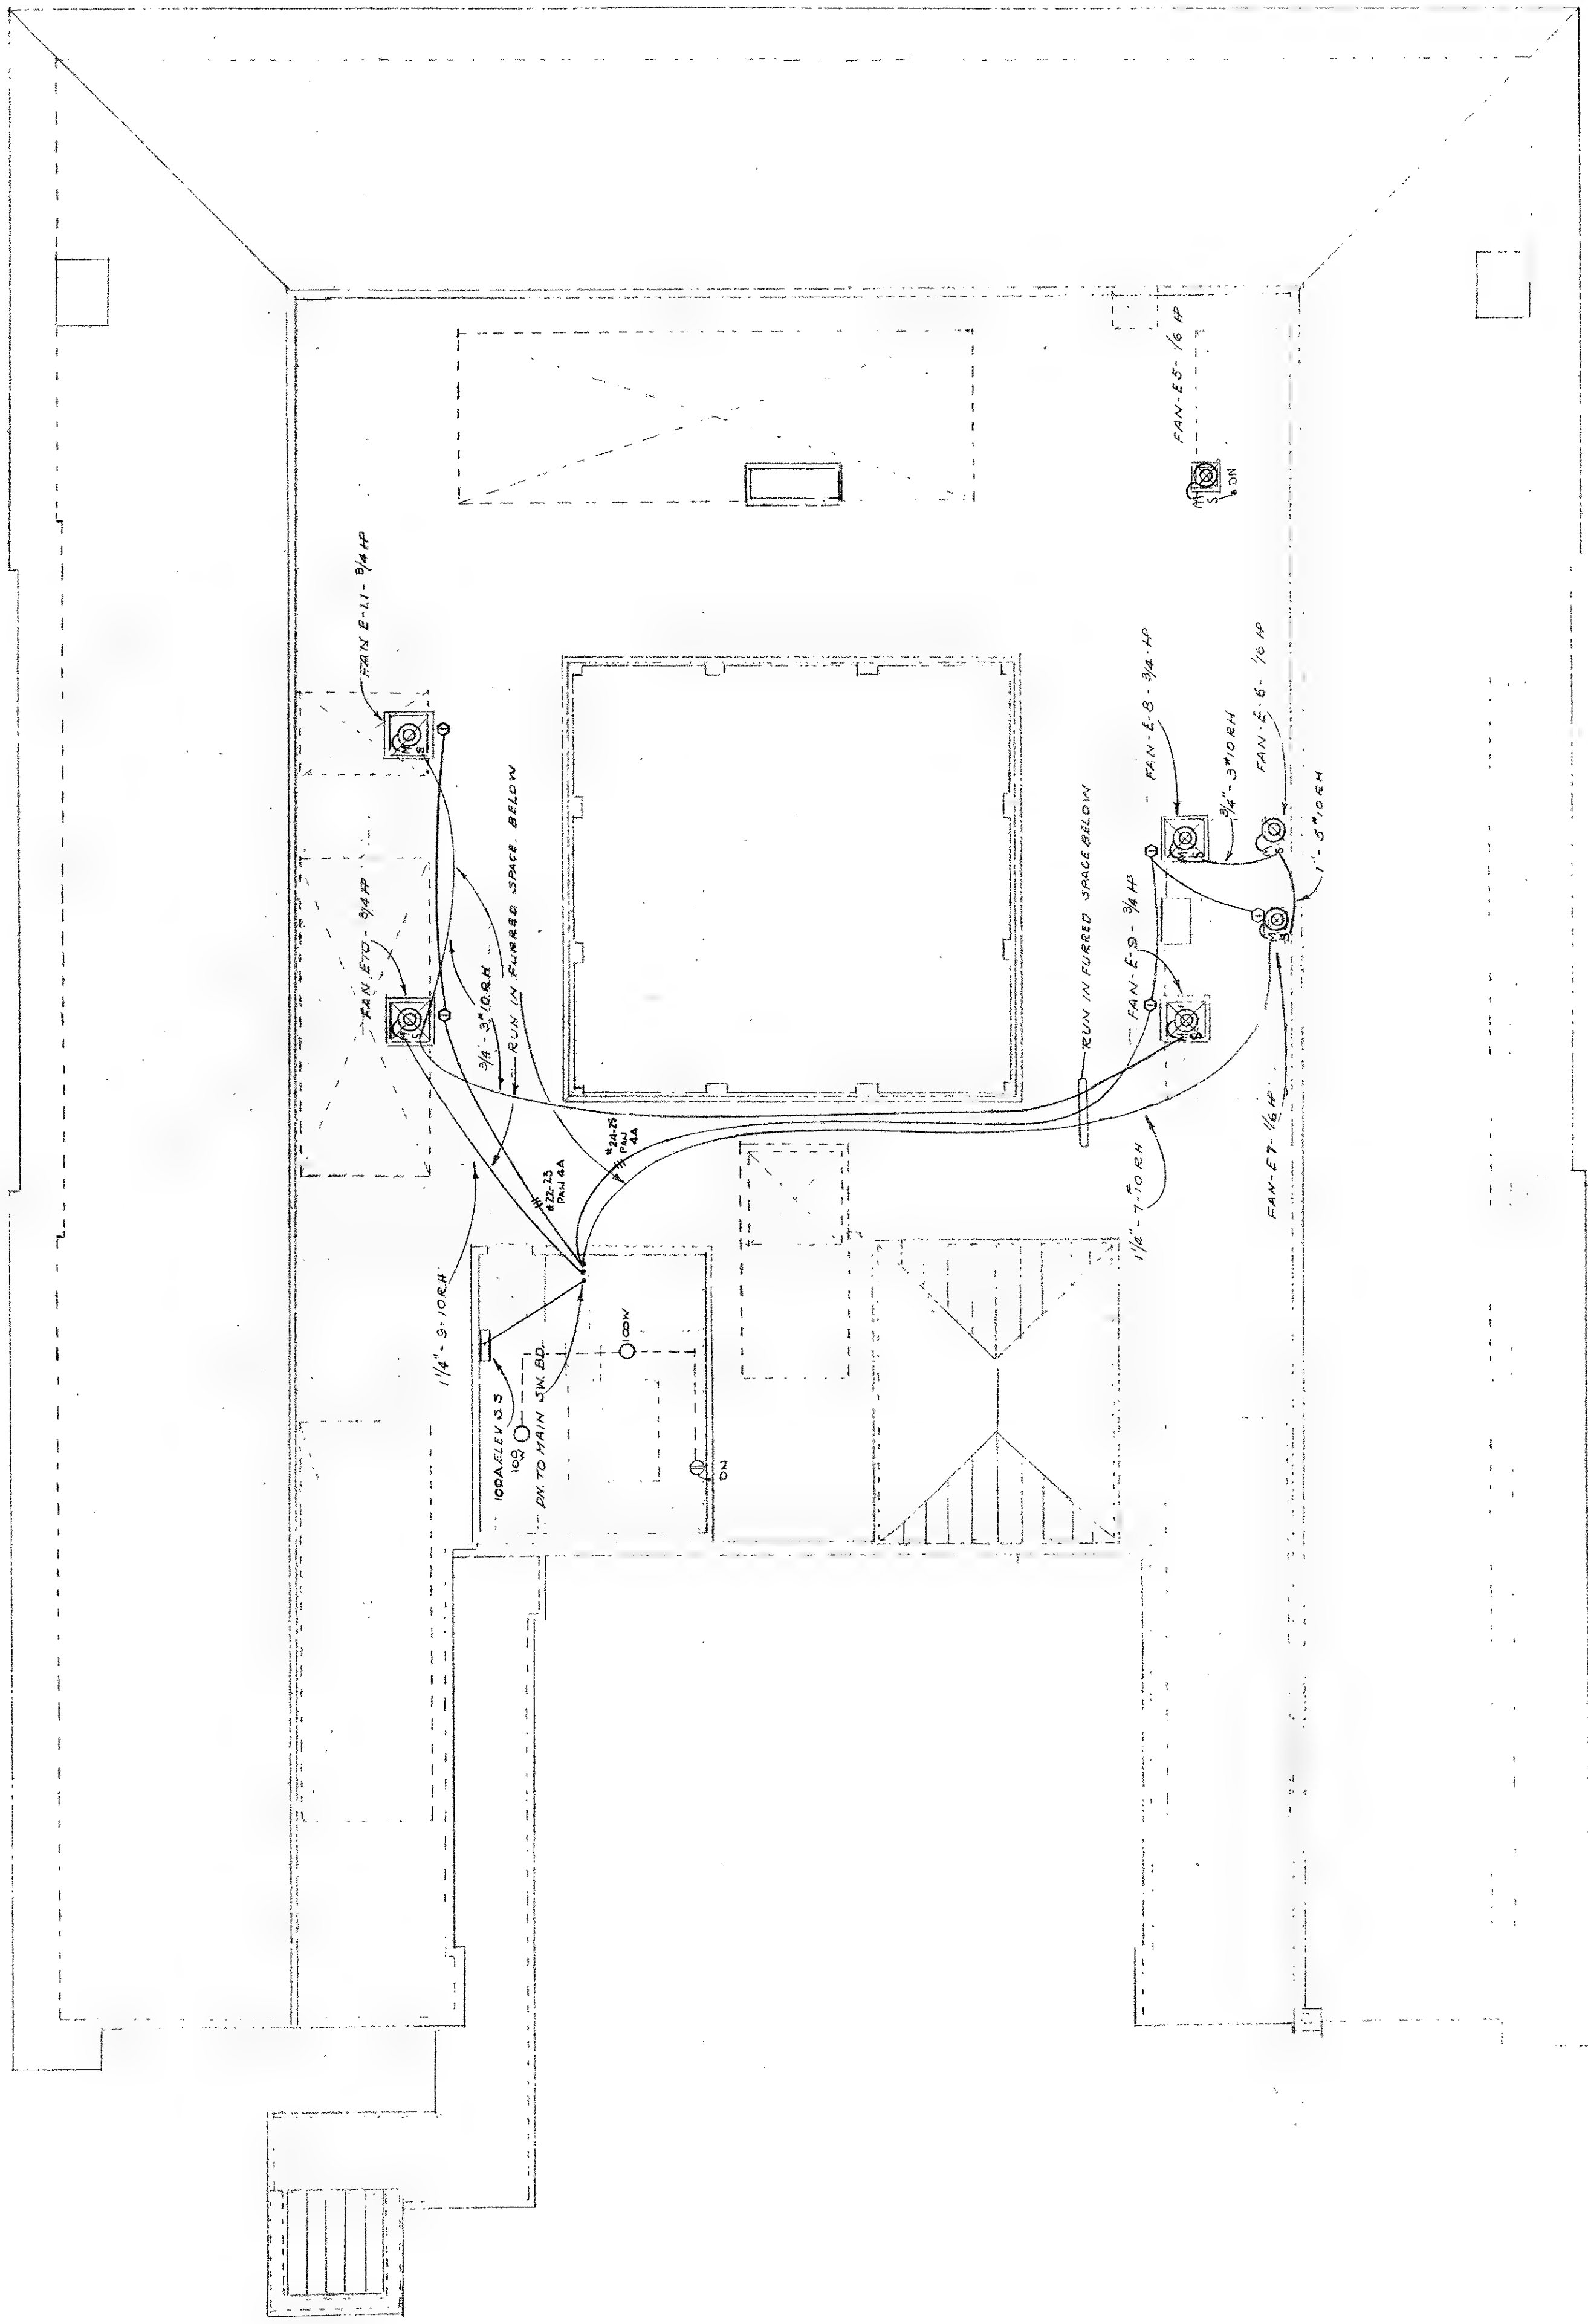


NOTES-  
 THIS DRAWING SUPERSEDES THE LIGHTING LAYOUT AS SHOWN ON DRAWING  
 E-7, OF ROOM 410  
 THIS DRAWING INDICATES CHANGES ONLY. ALL OTHER WIRING UNLESS  
 INDICATED HEREON REMAINS AS ORIGINALLY SHOWN ON PLAN E-7

REVISED LIGHTING LAYOUT- RM 410

ELECTRICAL	
REVISIONS	PART 4TH FLOOR PLAN-EMA10
	ALTERATIONS TO MAIN BUILDING
	FOR
	THE FREE PUBLIC LIBRARY
	WASHINGTON ST. NEWARK, N.J.
DRAWN BY	SCALE 1/8"=1'-0" DATE 11/24/50
679	EPPLER & SEAMAN
E-7A	ARCHITECTS & ENGINEERS
	901 BROAD ST. NEWARK 2, N.J.









NOTE:  
 DUPLEX RECEPTACLES SHALL BE INSTALLED IN THE FOLLOWING  
 AS INDICATED

ELECTRICAL		ROOF PLAN	
REVISIONS		ALTERATIONS TO MAIN BLDG	
		FOR	
		THE FREE PUBLIC LIBRARY	
		WASHINGTON ST	NEWARK N.J.
		DRAWN BY EEB	SCALE 1/8" = 1'-0"
		DATE APR 1, 1901	
679		EPPLE & SEAMAN	
E-8		ARCHITECTS & ENGINEERS	
		901 BROAD STREET, NEWARK 2 N.J.	



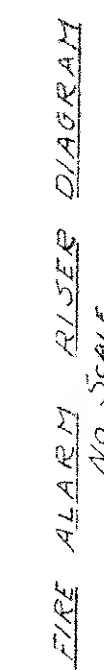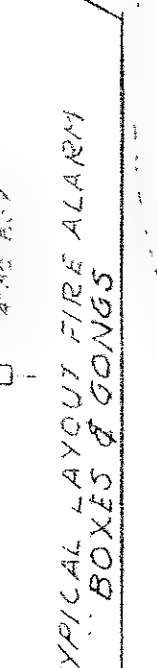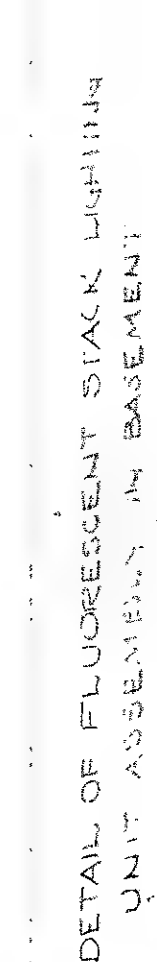

BASEMENT

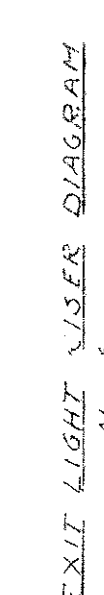

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ELECTRICAL	RISERS & DETAILS	ALTERNATES TO MAIN BLDG FOR THE FREE PUBLIC LIBRARY WASHINGTON ST NEWARK N.J.
REVISIONS		DRAWN BY: ERS SCALE AS SHOWN DATE APR. 1, 80
		APPLE & SEAMAN ARCHITECTS - ENGINEERS 901 BROAD STREET, NEWARK 2, N. J.
		679 E-9







ELECTRIC LEGEND	
○	CILING OUTLET
⊙	1" TYPING OUTLET (SEE NO. BACKSET/RECEPTACLE)
⊖	4" FLOOR ESCAPE UNIT (NUMBER INDICATE TUBES)
⊖	6" "
⊖	42" SINGLE TUBE UNIT
⊖	60" "
⊖	72" "
⊖	84" "
⊖	REAR OUTLET
⊖	NIGHT LIGHT
⊖	EXIT LIGHT
⊖	RECEPTACLE
⊖	JUNCTION BOX
⊖	SPOT LIGHT FIXTURE
⊖	FLOOR INCAHENT OUTLET
⊖	1" BELL TELEPHONE CONDUIT CONNECTED ONLY WHEN INDICATED
⊖	FLOOR BOX
⊖	PUSH BUTTON
⊖	EXECUTIVE MASTER STATION
⊖	SUB MASTER STATION
⊖	STATION
⊖	RADIO SPEAKER OUTLET
⊖	PHONOGRAPH PICKUP OUTLET
⊖	MICROPHONE
⊖	SOUND TRACK RECEPTACLE
⊖	TELEVISION JUNCTION BOX
⊖	20 AMP RECEPTACLE
⊖	RADIO CONTROL PANEL
⊖	SWAY SWITCH
⊖	4 WAY SWITCH
⊖	MOMENTARY CONTACT SWITCH
⊖	MOTOR STARTER
⊖	LIGHTING PANEL
⊖	TELEPHONE CABINET
⊖	COMBINATION LIT & TOWER PANEL
⊖	MOTOR NUMBER INDICATED 1P
⊖	CONCEALED CONDUIT IN FURRED SPACE
⊖	CONCEALED CONDUIT IN FLOOR ABOVE & DOWN TO OUTLET
⊖	CONCEALED CONDUIT IN FLOOR
⊖	EXPOSED CONDUIT ALONG CEILING BELOW
⊖	CONCEALED CONDUIT IN WALL OR PLASTER (WHERE NOT SHOWN)
⊖	FIRE ALARM BOX
⊖	FIRE ALARM BELL
⊖	THERMOSTAT
⊖	NIGHT LIGHT CIRCUIT
⊖	EXISTING CONDUIT
⊖	WEATHER PROOF
⊖	BELL
⊖	FLUOR LIT UNIT & WIREWAY ASSEMBLY (BASEMENT ONLY)
⊖	OIL BURNER EMERGENCY LIT OFF
⊖	CLOCK OUTLET
⊖	DOOR BELL
⊖	PAN RECEPTACLE

MAIN SWITCHBOARD SCHEDULE									
LINE NO.	DESIGNATION	REMARKS	ADDITIONAL CIRCUITS	TYPE OF OUTLET	TYPE OF SWITCH	TYPE OF BREAKER	TYPE OF FUSE	TYPE OF FUSE	REMARKS
1	MAIN BREAKER								175 TYPE KC
2	PANEL 1A	1000 1500 TYPE KC 30A 3P W BUSED							
3	PANEL 2A	1000 1500 TYPE KC 30A 3P W BUSED							
4	PANEL 3A	1000 1500 TYPE KC 30A 3P W BUSED							
60	PANEL 59A	1000 1500 TYPE KC 30A 3P W BUSED							
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62	PANEL 61A	1000 1500 TYPE KC 30A 3P W BUSED							
63	PANEL 62A	1000 1500 TYPE KC 30A 3P W BUSED							
64	PANEL 63A	1000 1500 TYPE KC 30A 3P W BUSED							
65	PANEL 64A	1000 1500 TYPE KC 30A 3P W BUSED							
66	PANEL 65A	1000 1500 TYPE KC 30A 3P W BUSED							
67	PANEL 66A	1000 1500 TYPE KC 30A 3P W BUSED							
68	PANEL 67A	1000 1500 TYPE KC 30A 3P W BUSED							
69	PANEL 68A	1000 1500 TYPE KC 30A 3P W BUSED							
70	PANEL 69A	1000 1500 TYPE KC 30A 3P W BUSED							
71	PANEL 70A	1000 1500 TYPE KC 30A 3P W BUSED							
72	PANEL 71A	1000 1500 TYPE KC 30A 3P W BUSED							
73	PANEL 72A	1000 1500 TYPE KC 30A 3P W BUSED							
74	PANEL 73A	1000 1500 TYPE KC 30A 3P W BUSED							
75	PANEL 74A	1000 1500 TYPE KC 30A 3P W BUSED							
76	PANEL 75A	1000 1500 TYPE KC 30A 3P W BUSED							
77	PANEL 76A	1000 1500 TYPE KC 30A 3P W BUSED							
78	PANEL 77A	1000 1500 TYPE KC 30A 3P W BUSED							
79	PANEL 78A	1000 1500 TYPE KC 30A 3P W BUSED							
80	PANEL 79A	1000 1500 TYPE KC 30A 3P W BUSED							
81	PANEL 80A	1000 1500 TYPE KC 30A 3P W BUSED							
82	PANEL 81A	1000 1500 TYPE KC 30A 3P W BUSED							
83	PANEL 82A	1000 1500 TYPE KC 30A 3P W BUSED							
84	PANEL 83A	1000 1500 TYPE KC 30A 3P W BUSED							
85	PANEL 84A	1000 1500 TYPE KC 30A 3P W BUSED							
86	PANEL 85A	1000 1500 TYPE KC 30A 3P W BUSED							
87	PANEL 86A	1000 1500 TYPE KC 30A 3P W BUSED							
88	PANEL 87A	1000 1500 TYPE KC 30A 3P W BUSED							
89	PANEL 88A	1000 1500 TYPE KC 30A 3P W BUSED							
90	PANEL 89A	1000 1500 TYPE KC 30A 3P W BUSED							
91	PANEL 90A	1000 1500 TYPE KC 30A 3P W BUSED							
92	PANEL 91A	1000 1500 TYPE KC 30A 3P W BUSED							
93	PANEL 92A	1000 1500 TYPE KC 30A 3P W BUSED							
94	PANEL 93A	1000 1500 TYPE KC 30A 3P W BUSED							
95	PANEL 94A	1000 1500 TYPE KC 30A 3P W BUSED							
96	PANEL 95A	1000 1500 TYPE KC 30A 3P W BUSED							
97	PANEL 96A	1000 1500 TYPE KC 30A 3P W BUSED							
98	PANEL 97A	1000 1500 TYPE KC 30A 3P W BUSED							
99	PANEL 98A	1000 1500 TYPE KC 30A 3P W BUSED							
100	PANEL 99A	1000 1500 TYPE KC 30A 3P W BUSED							

MOTOR CONTROL CENTER									
DESIGNATION	X-2 COMBINATION MOTOR FRAME SIZE WITH THERMAL BREAK PROTECTION					REMARKS	* AMPERE RATING		
	2-1/2	3	4	5	THREE PHASE				
VENT FAN E-3	0	1/6		5	3 POLE 1P	0-5			
VENT FAN E-11	0	1/6		5	3 POLE 1P	0-5			
VENT FAN E-5	0	3/4		5	3 POLE 3P	0-12			
VENT FAN E-10	0	3/4		5	3 POLE 3P	0-12			
VENT FAN E-11	0	3/4		5	3 POLE 3P	0-12			
VENT FAN E-11	0	3/4		5	3 POLE 3P	0-12			
VENT FAN E-11	0	2		10	3 POLE 3P	0-20			
EXPANSION E-11	0	1		5	3 POLE 3P	0-10			
AIR COMP LAMPSON TUBE	1			23	3 POLE 3P	0-40			
BOLLEE PAK E-11 FAN	1	5		23	3 POLE 3P	0-140			
VENT FAN E-3	0	3/4		5	3 POLE 3P	0-17			
VENT FAN E-2	0	1/6		5	3 POLE 1P	0-5			
VENT FAN E-4	0	1/2		5	3 POLE 3P	0-12			



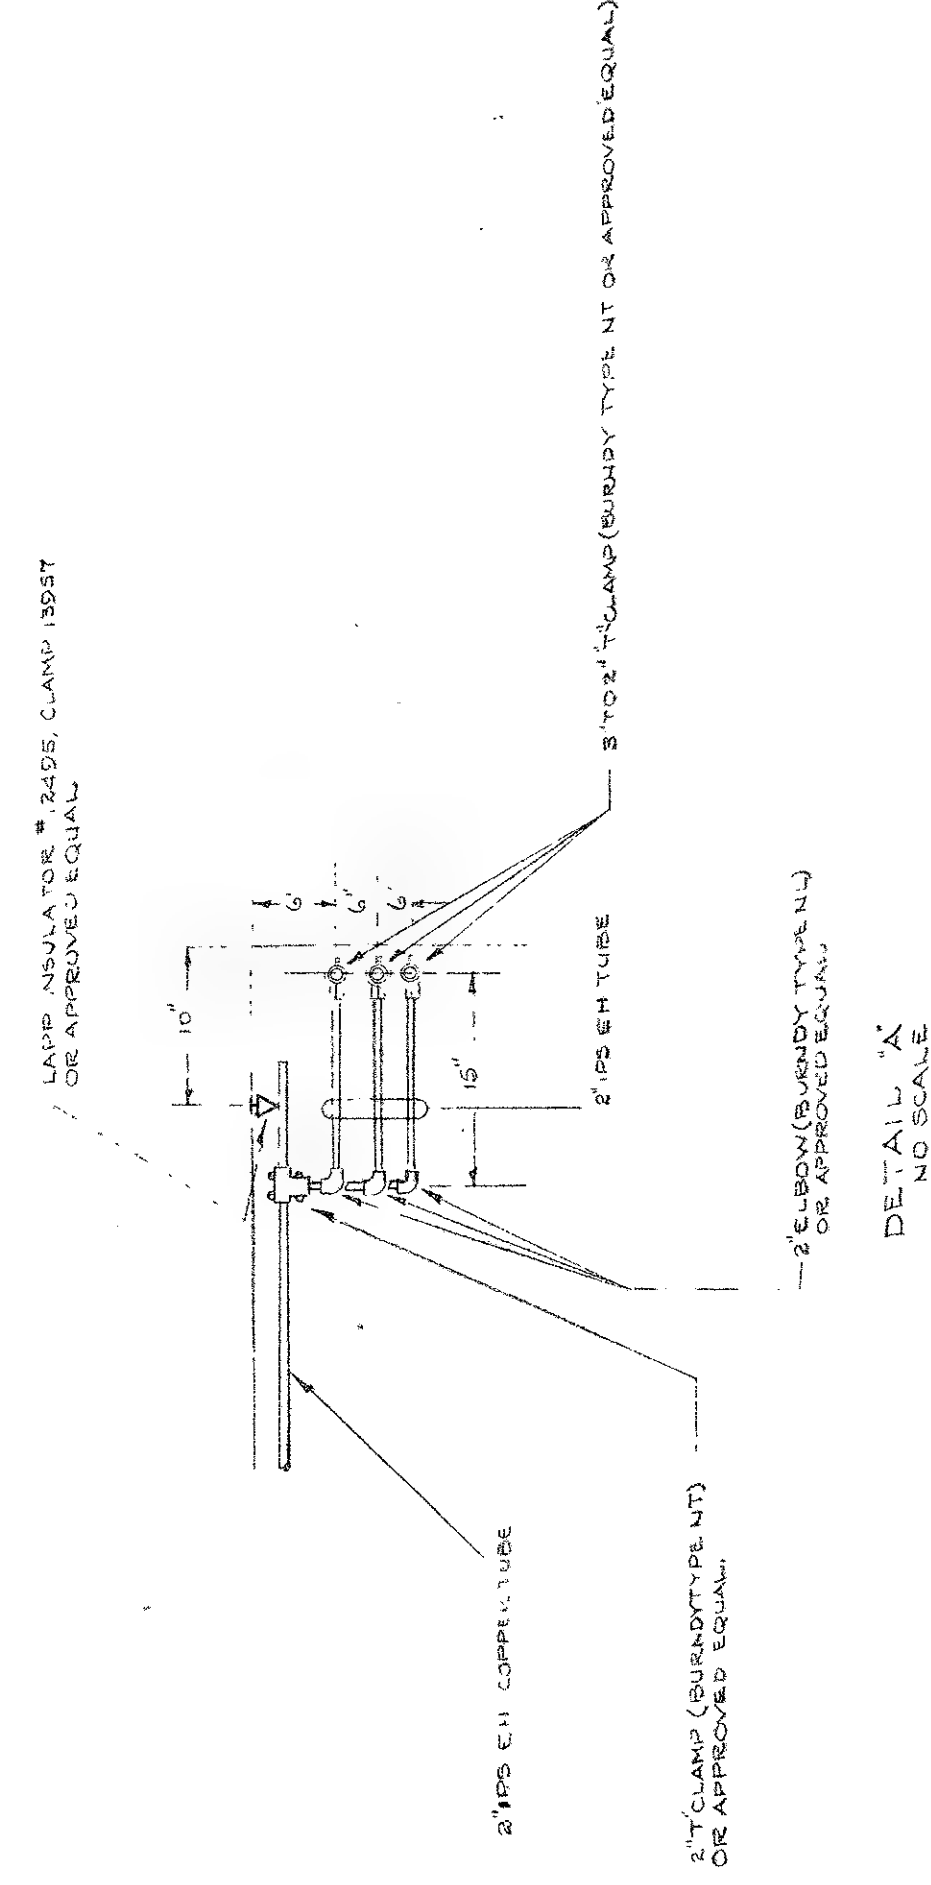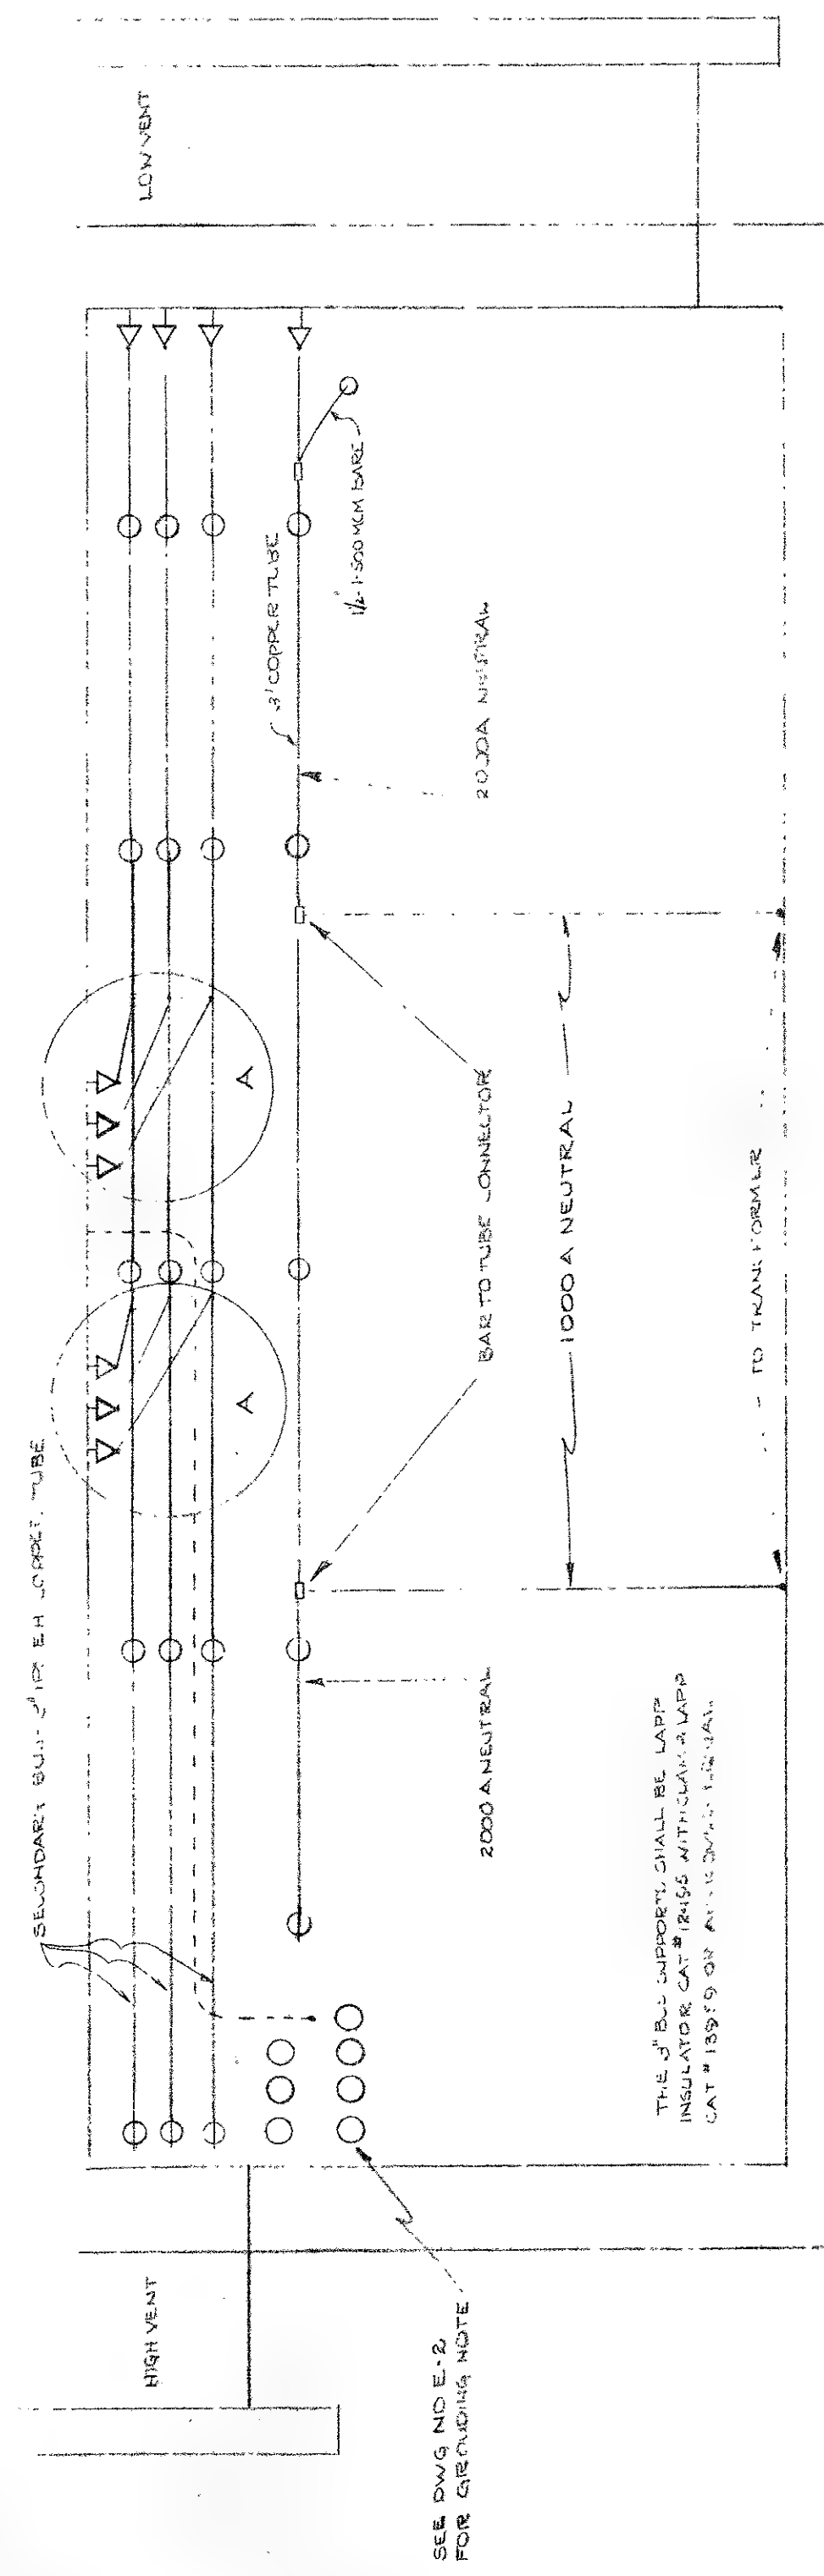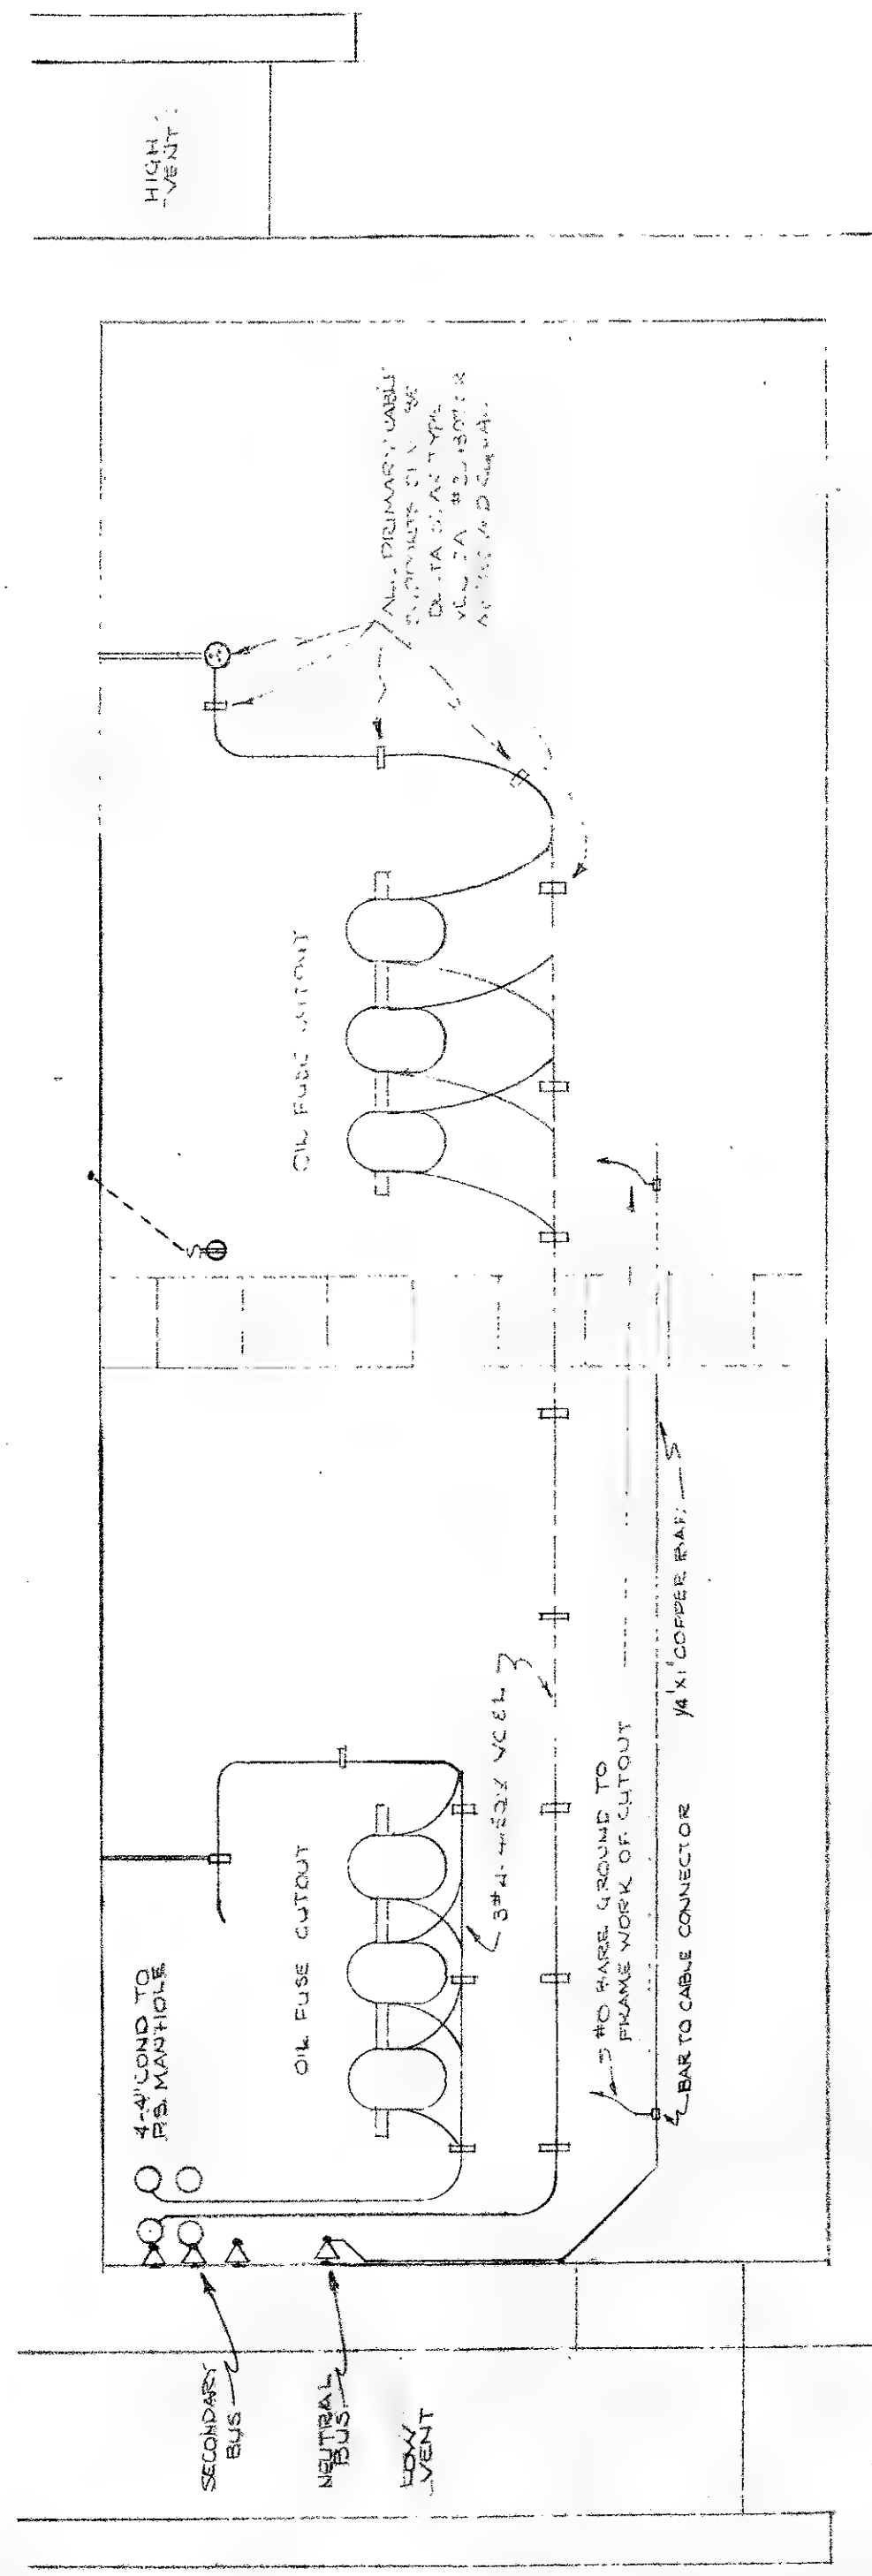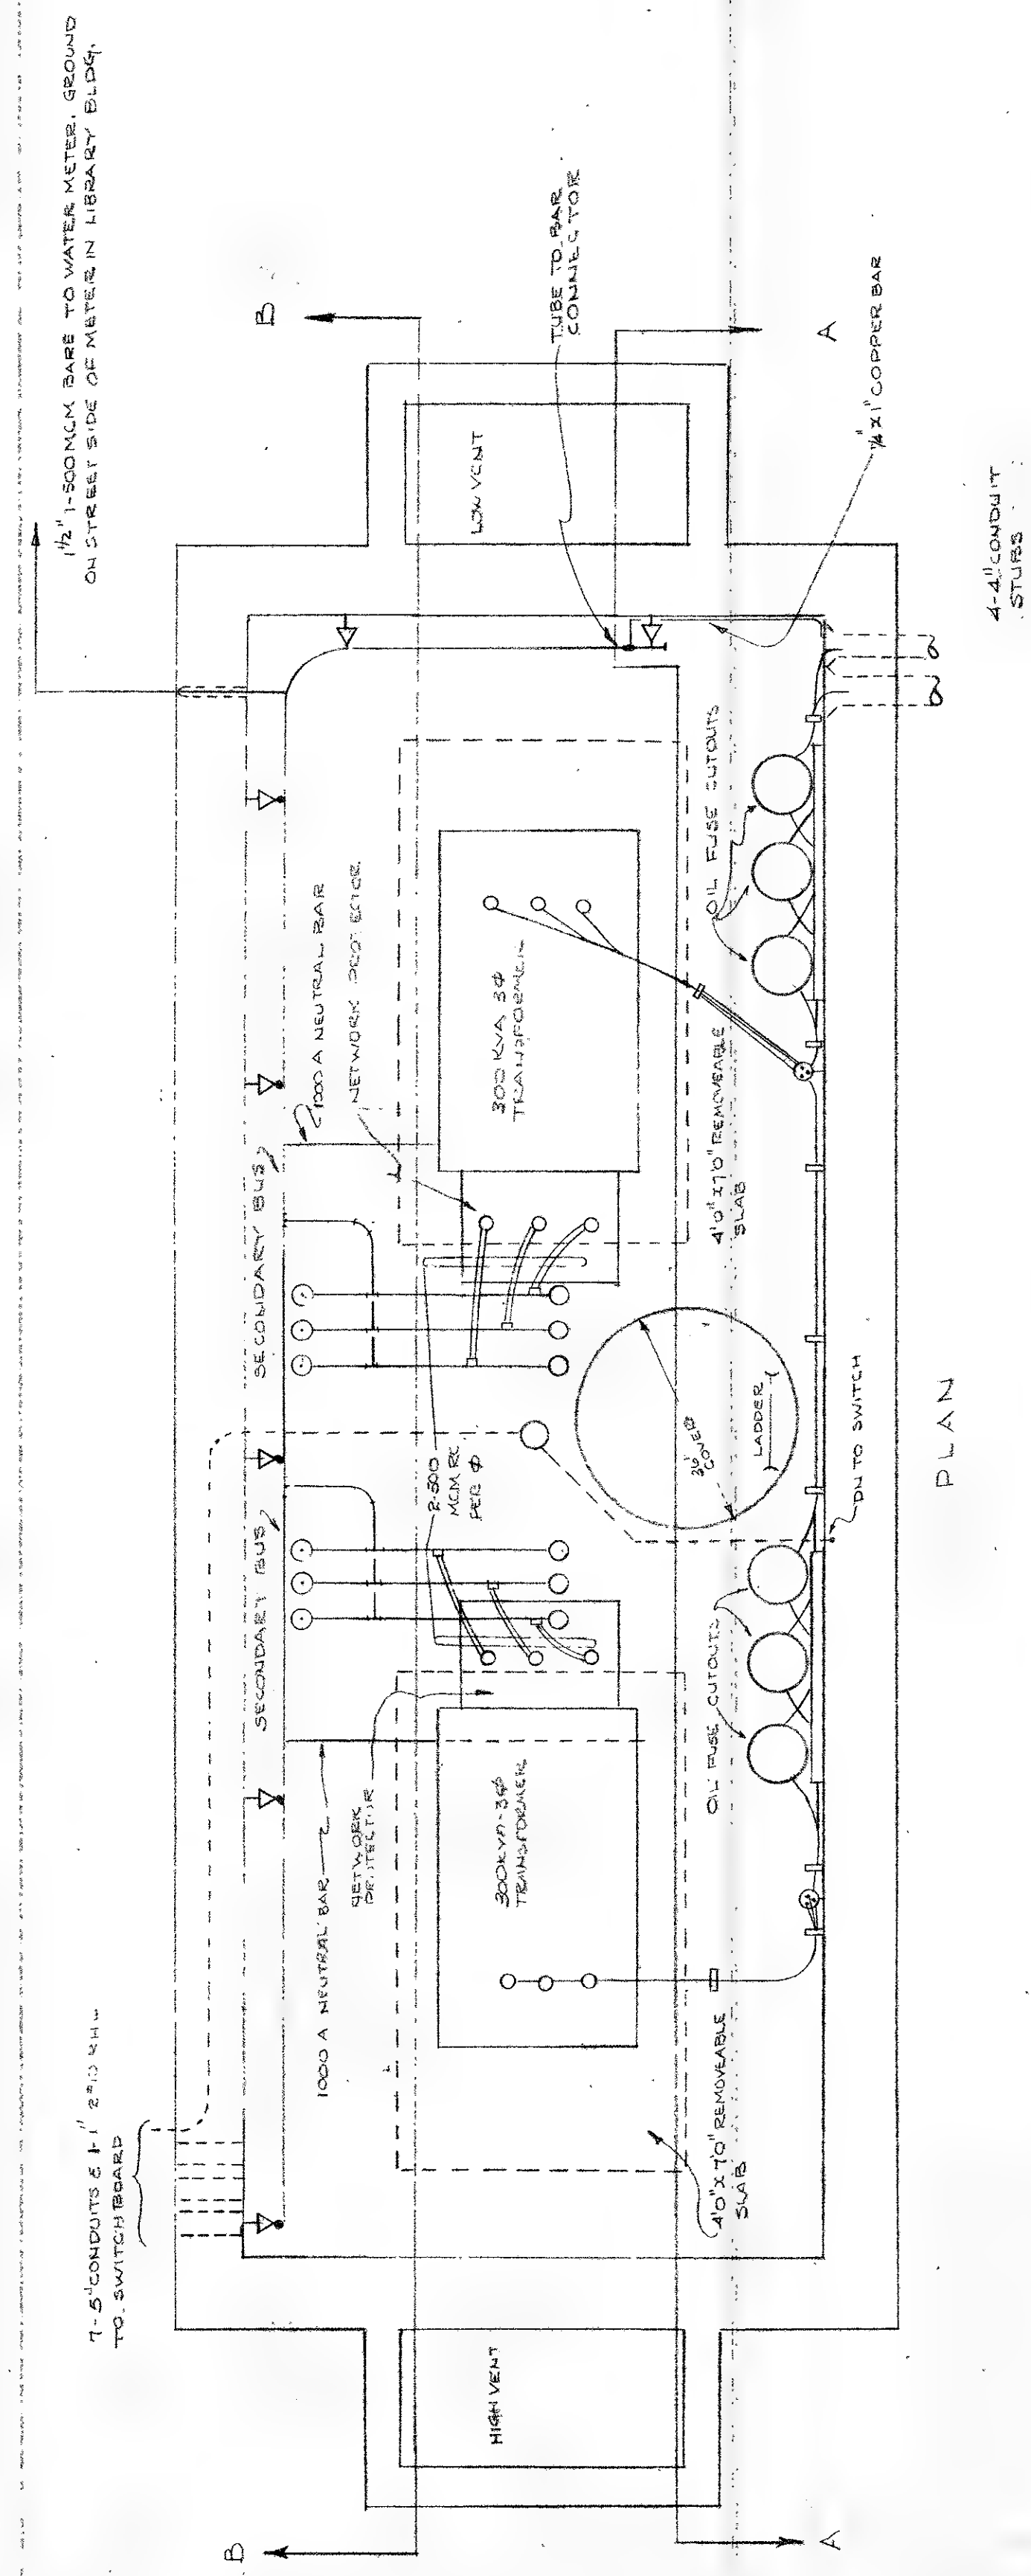


EQUIPMENT TO BE SUPPLIED BY PUBLIC SERVICES ELECTRIC & GAS CO.  
300 KVA TRANSFORMER & DRY OIL FUSE CUTOUT  
TWO 1200 AMP FUSE PROTECTORS WITH MECHANICAL  
CONNECTORS FOR 2-500 ACM 1/2 INCH PER PHASE  
PRIMARY CABLE OF SUFFICIENT LENGTH TO REACH OIL FUSE CUTOUTS  
INCLUDING CONDUIT RELAYS PROXIMATE TO STREET  
SECONDARY CABLE OF SUFFICIENT LENGTH TO REACH SECONDARY BUS  
WORK TO BE DONE BY PUBLIC SERVICES ELECTRIC & GAS CO.



GENERAL NOTES  
ALL OTHER EQUIPMENT & WIRING TO BE SUPPLIED & INSTALLED BY CUSTOMER  
ALL CONNECTIONS TO MAIN BUS TO BE MADE WITH VEH. CONNECTORS  
APPROVED BY BSEE & CO.  
INSULATE ALL COPPER BUS & COAT WITH WATERPROOF VARNISH  
APPROVED BY BSEE & CO.  
CONTRACTOR TO SUBMIT CONSTRUCTION DRAWINGS TO BSEE & CO  
FOR APPROVAL  
BOND ALL CONDUITS ENTERING VAULT FROM BUILDING TO THE  
NEUTRAL BUS

679 E12	ELECTRICAL TRANSFORMER VAULT ALTERATIONS TO MAIN BLDG THE FREE PUBLIC LIBRARY WASHINGTON ST NEWARK N.J.	DRAWN BY SCALE 1/4" = 1'-0"	DATE JAN 1950
	APPLE & SEAMAN ARCHITECTS & ENGINEERS 901 BRADDO STREET, NEWARK, N.J.		



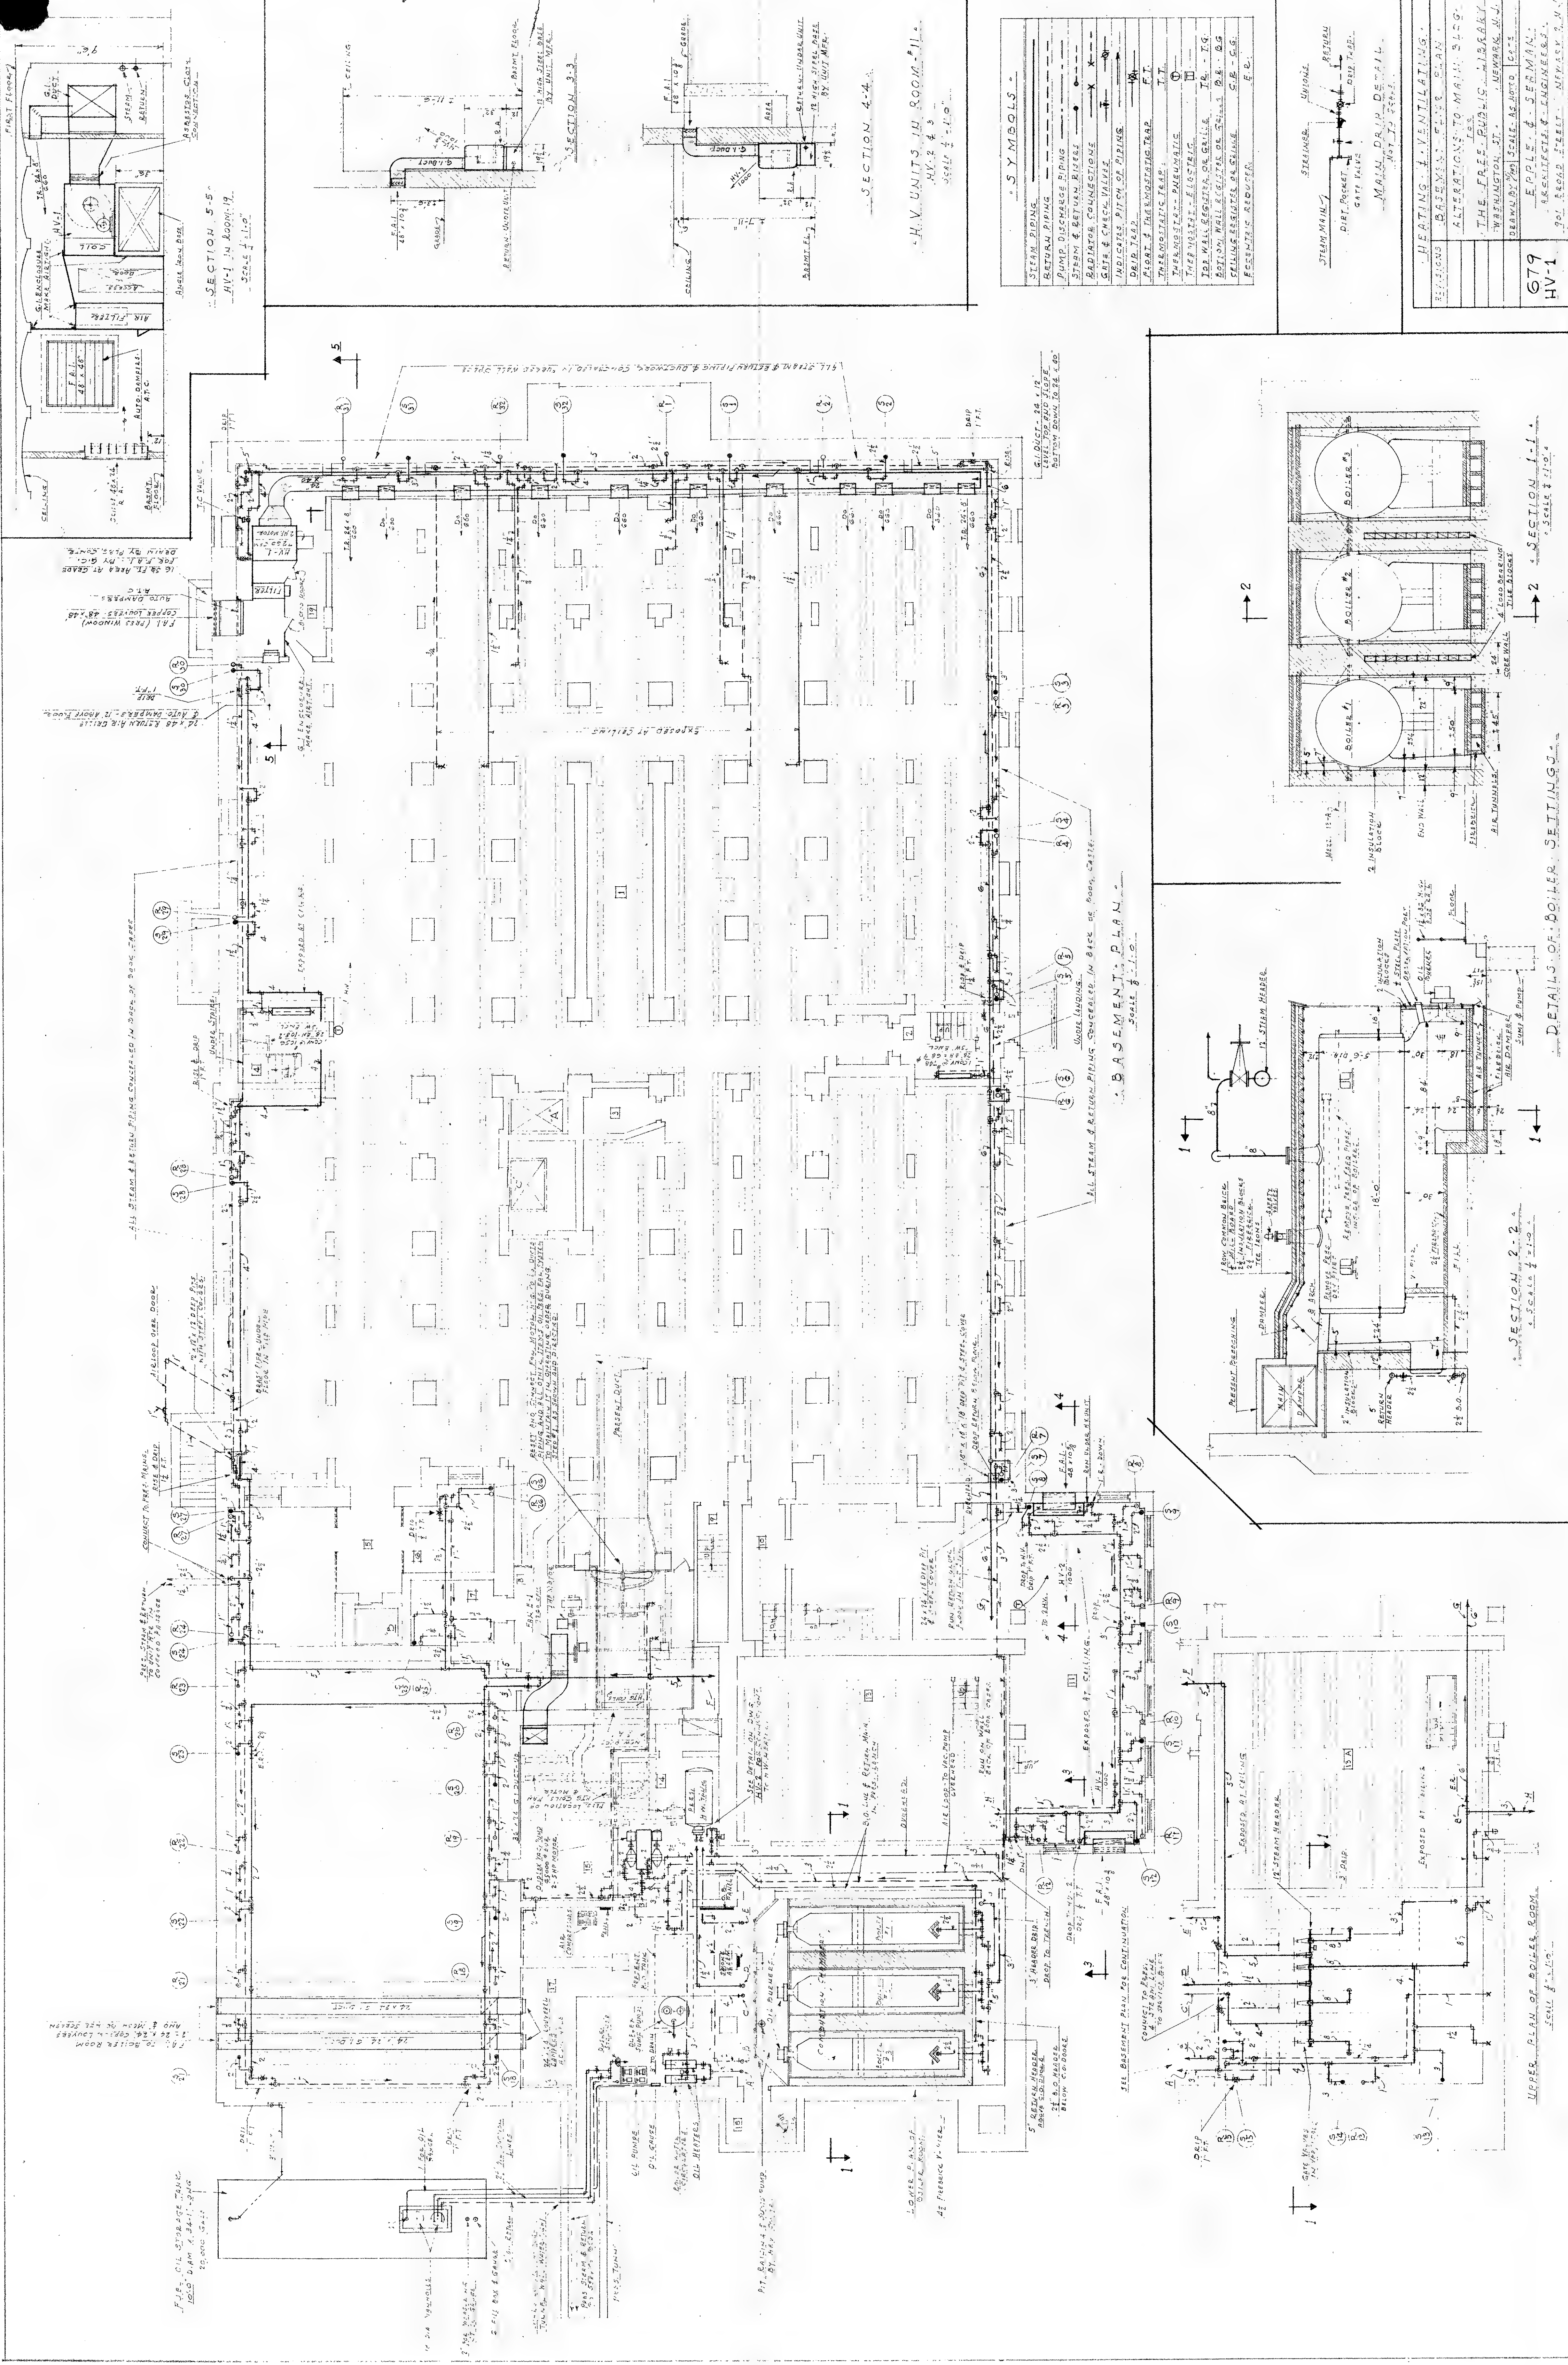






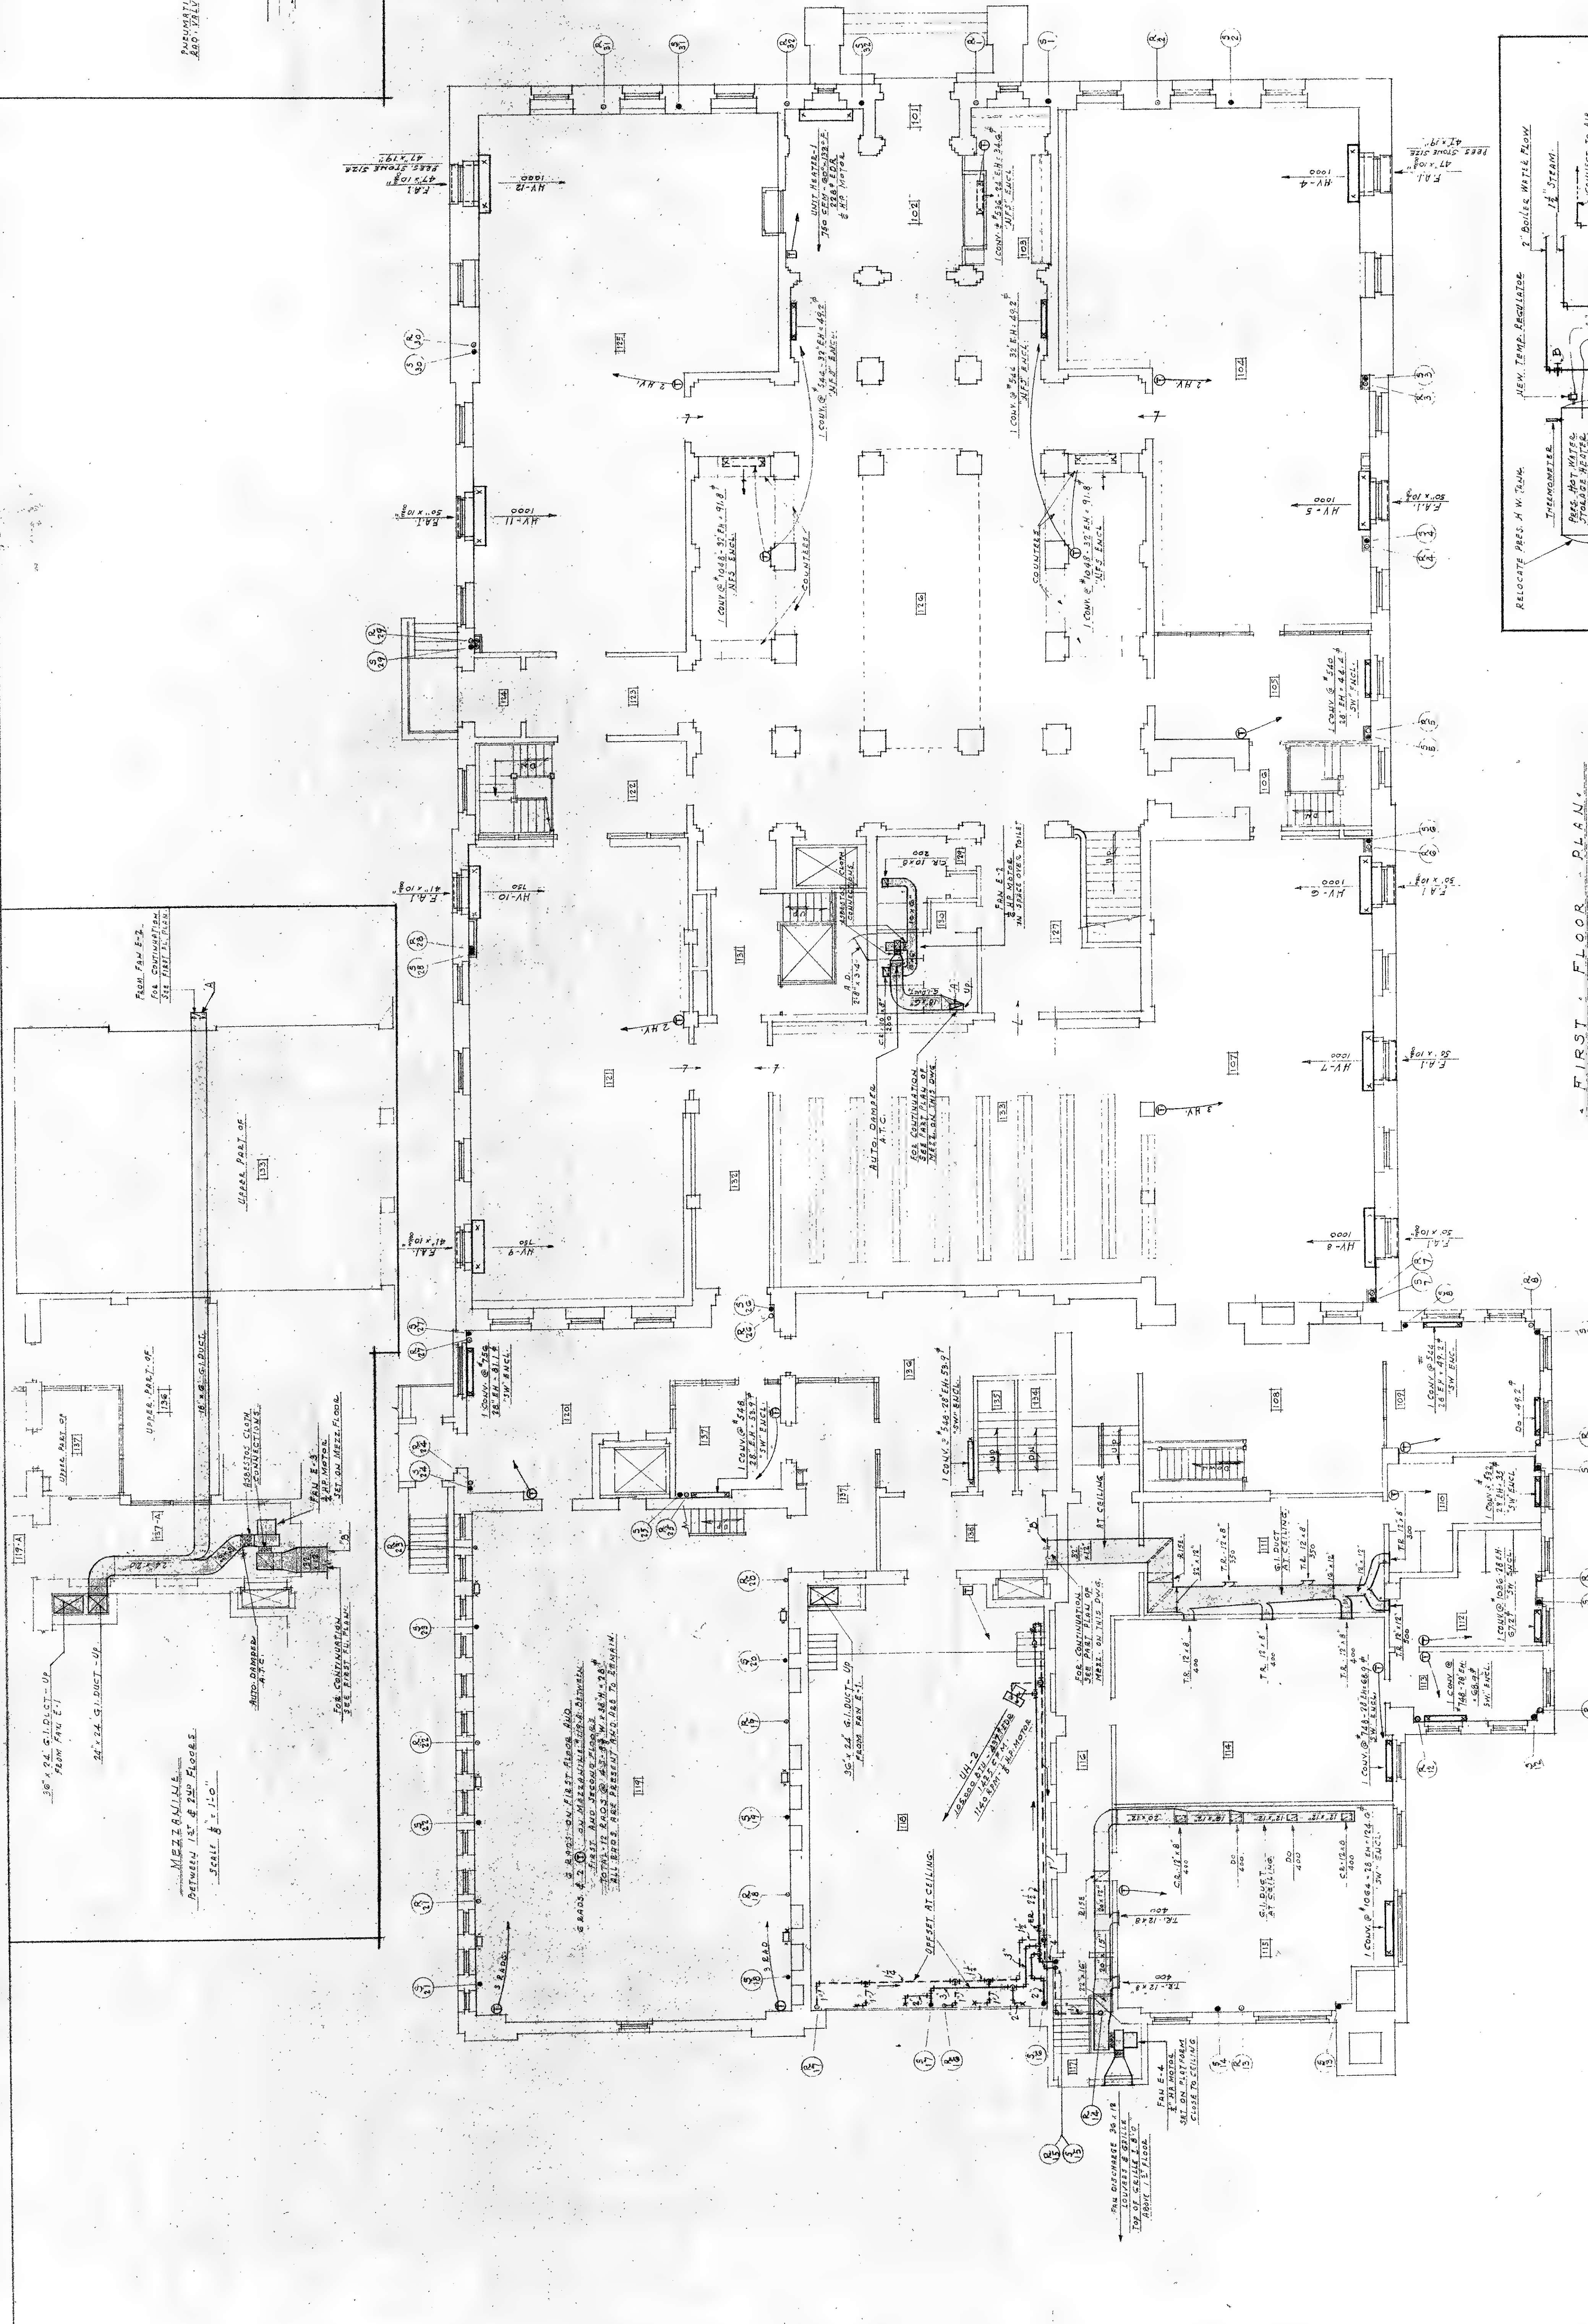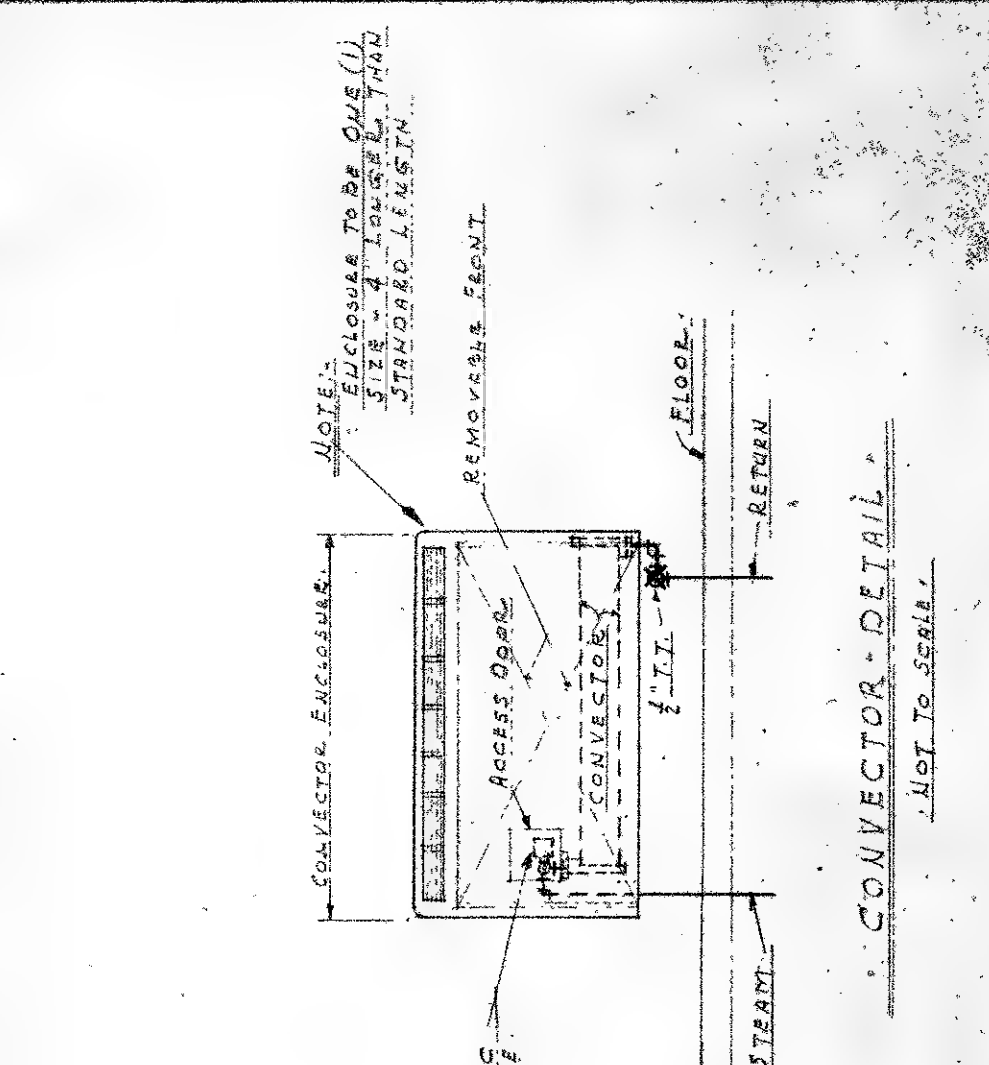





FIRST FLOOR PLAN  
Scale 1/8" = 1'-0"

RADIATOR CONNECTIONS			
STEAM	50 FT.	REVIEW	
BRANCH	1/2"	1/2"	1/2"
1"	0-75	1/2"	1/2"
1 1/2"	76-125	1/2"	1/2"
2"	126-175	1/2"	1/2"
2 1/2"	176-225	1/2"	1/2"
3"	226-275	1/2"	1/2"
3 1/2"	276-325	1/2"	1/2"
4"	326-375	1/2"	1/2"
4 1/2"	376-425	1/2"	1/2"
5"	426-475	1/2"	1/2"
5 1/2"	476-525	1/2"	1/2"
6"	526-575	1/2"	1/2"
6 1/2"	576-625	1/2"	1/2"
7"	626-675	1/2"	1/2"
7 1/2"	676-725	1/2"	1/2"
8"	726-775	1/2"	1/2"
8 1/2"	776-825	1/2"	1/2"
9"	826-875	1/2"	1/2"
9 1/2"	876-925	1/2"	1/2"
10"	926-975	1/2"	1/2"
10 1/2"	976-1025	1/2"	1/2"
11"	1026-1075	1/2"	1/2"
11 1/2"	1076-1125	1/2"	1/2"
12"	1126-1175	1/2"	1/2"
12 1/2"	1176-1225	1/2"	1/2"
13"	1226-1275	1/2"	1/2"
13 1/2"	1276-1325	1/2"	1/2"
14"	1326-1375	1/2"	1/2"
14 1/2"	1376-1425	1/2"	1/2"
15"	1426-1475	1/2"	1/2"
15 1/2"	1476-1525	1/2"	1/2"
16"	1526-1575	1/2"	1/2"
16 1/2"	1576-1625	1/2"	1/2"
17"	1626-1675	1/2"	1/2"
17 1/2"	1676-1725	1/2"	1/2"
18"	1726-1775	1/2"	1/2"
18 1/2"	1776-1825	1/2"	1/2"
19"	1826-1875	1/2"	1/2"
19 1/2"	1876-1925	1/2"	1/2"
20"	1926-1975	1/2"	1/2"
20 1/2"	1976-2025	1/2"	1/2"
21"	2026-2075	1/2"	1/2"
21 1/2"	2076-2125	1/2"	1/2"
22"	2126-2175	1/2"	1/2"
22 1/2"	2176-2225	1/2"	1/2"
23"	2226-2275	1/2"	1/2"
23 1/2"	2276-2325	1/2"	1/2"
24"	2326-2375	1/2"	1/2"
24 1/2"	2376-2425	1/2"	1/2"
25"	2426-2475	1/2"	1/2"
25 1/2"	2476-2525	1/2"	1/2"
26"	2526-2575	1/2"	1/2"
26 1/2"	2576-2625	1/2"	1/2"
27"	2626-2675	1/2"	1/2"
27 1/2"	2676-2725	1/2"	1/2"
28"	2726-2775	1/2"	1/2"
28 1/2"	2776-2825	1/2"	1/2"
29"	2826-2875	1/2"	1/2"
29 1/2"	2876-2925	1/2"	1/2"
30"	2926-2975	1/2"	1/2"
30 1/2"	2976-3025	1/2"	1/2"
31"	3026-3075	1/2"	1/2"
31 1/2"	3076-3125	1/2"	1/2"
32"	3126-3175	1/2"	1/2"
32 1/2"	3176-3225	1/2"	1/2"
33"	3226-3275	1/2"	1/2"
33 1/2"	3276-3325	1/2"	1/2"
34"	3326-3375	1/2"	1/2"
34 1/2"	3376-3425	1/2"	1/2"
35"	3426-3475	1/2"	1/2"
35 1/2"	3476-3525	1/2"	1/2"
36"	3526-3575	1/2"	1/2"
36 1/2"	3576-3625	1/2"	1/2"
37"	3626-3675	1/2"	1/2"
37 1/2"	3676-3725	1/2"	1/2"
38"	3726-3775	1/2"	1/2"
38 1/2"	3776-3825	1/2"	1/2"
39"	3826-3875	1/2"	1/2"
39 1/2"	3876-3925	1/2"	1/2"
40"	3926-3975	1/2"	1/2"
40 1/2"	3976-4025	1/2"	1/2"
41"	4026-4075	1/2"	1/2"
41 1/2"	4076-4125	1/2"	1/2"
42"	4126-4175	1/2"	1/2"
42 1/2"	4176-4225	1/2"	1/2"
43"	4226-4275	1/2"	1/2"
43 1/2"	4276-4325	1/2"	1/2"
44"	4326-4375	1/2"	1/2"
44 1/2"	4376-4425	1/2"	1/2"
45"	4426-4475	1/2"	1/2"
45 1/2"	4476-4525	1/2"	1/2"
46"	4526-4575	1/2"	1/2"
46 1/2"	4576-4625	1/2"	1/2"
47"	4626-4675	1/2"	1/2"
47 1/2"	4676-4725	1/2"	1/2"
48"	4726-4775	1/2"	1/2"
48 1/2"	4776-4825	1/2"	1/2"
49"	4826-4875	1/2"	1/2"
49 1/2"	4876-4925	1/2"	1/2"
50"	4926-4975	1/2"	1/2"
50 1/2"	4976-5025	1/2"	1/2"
51"	5026-5075	1/2"	1/2"
51 1/2"	5076-5125	1/2"	1/2"
52"	5126-5175	1/2"	1/2"
52 1/2"	5176-5225	1/2"	1/2"
53"	5226-5275	1/2"	1/2"
53 1/2"	5276-5325	1/2"	1/2"
54"	5326-5375	1/2"	1/2"
54 1/2"	5376-5425	1/2"	1/2"
55"	5426-5475	1/2"	1/2"
55 1/2"	5476-5525	1/2"	1/2"
56"	5526-5575	1/2"	1/2"
56 1/2"	5576-5625	1/2"	1/2"
57"	5626-5675	1/2"	1/2"
57 1/2"	5676-5725	1/2"	1/2"
58"	5726-5775	1/2"	1/2"
58 1/2"	5776-5825	1/2"	1/2"
59"	5826-5875	1/2"	1/2"
59 1/2"	5876-5925	1/2"	1/2"
60"	5926-5975	1/2"	1/2"
60 1/2"	5976-6025	1/2"	1/2"
61"	6026-6075	1/2"	1/2"
61 1/2"	6076-6125	1/2"	1/2"
62"	6126-6175	1/2"	1/2"
62 1/2"	6176-6225	1/2"	1/2"
63"	6226-6275	1/2"	1/2"
63 1/2"	6276-6325	1/2"	1/2"
64"	6326-6375	1/2"	1/2"
64 1/2"	6376-6425	1/2"	1/2"
65"	6426-6475	1/2"	1/2"
65 1/2"	6476-6525	1/2"	1/2"
66"	6526-6575	1/2"	1/2"
66 1/2"	6576-6625	1/2"	1/2"
67"	6626-6675	1/2"	1/2"
67 1/2"	6676-6725	1/2"	1/2"
68"	6726-6775	1/2"	1/2"
68 1/2"	6776-6825	1/2"	1/2"
69"	6826-6875	1/2"	1/2"
69 1/2"	6876-6925	1/2"	1/2"
70"	6926-6975	1/2"	1/2"
70 1/2"	6976-7025	1/2"	1/2"
71"	7026-7075	1/2"	1/2"
71 1/2"	7076-7125	1/2"	1/2"
72"	7126-7175	1/2"	1/2"
72 1/2"	7176-7225	1/2"	1/2"
73"	7226-7275	1/2"	1/2"
73 1/2"	7276-7325	1/2"	1/2"
74"	7326-7375	1/2"	1/2"
74 1/2"	7376-7425	1/2"	1/2"
75"	7426-7475	1/2"	1/2"
75 1/2"	7476-7525	1/2"	1/2"
76"	7526-7575	1/2"	1/2"
76 1/2"	7576-7625	1/2"	1/2"
77"	7626-7675	1/2"	1/2"
77 1/2"	7676-7725	1/2"	1/2"
78"	7726-7775	1/2"	1/2"
78 1/2"	7776-7825	1/2"	1/2"
79"	7826-7875	1/2"	1/2"
79 1/2"	7876-7925	1/2"	1/2"
80"	7926-7975	1/2"	1/2"
80 1/2"	7976-8025	1/2"	1/2"
81"	8026-8075	1/2"	1/2"
81 1/2"	8076-8125	1/2"	1/2"
82"	8126-8175	1/2"	1/2"
82 1/2"	8176-8225	1/2"	1/2"
83"	8226-8275	1/2"	1/2"
83 1/2"	8276-8325	1/2"	1/2"
84"	8326-8375	1/2"	1/2"
84 1/2"	8376-8425	1/2"	1/2"
85"	8426-8475	1/2"	1/2"
85 1/2"	8476-8525	1/2"	1/2"
86"	8526-8575	1/2"	1/2"
86 1/2"	8576-8625	1/2"	1/2"
87"	8626-8675	1/2"	1/2"
87 1/2"	8676-8725	1/2"	1/2"
88"	8726-8775	1/2"	1/2"
88 1/2"	8776-8825	1/2"	1/2"
89"	8826-8875	1/2"	1/2"
89 1/2"	8876-8925	1/2"	1/2"
90"	8926-8975	1/2"	1/2"
90 1/2"	8976-9025	1/2"	1/2"
91"	9026-9075	1/2"	1/2"
91 1/2"	9076-9125	1/2"	1/2"
92"	9126-9175	1/2"	1/2"
92 1/2"	9176-9225	1/2"	1/2"
93"	9226-9275	1/2"	1/2"
93 1/2"	9276-9325	1/2"	1/2"
94"	9326-9375	1/2"	1/2"
94 1/2"	9376-9425	1/2"	1/2"
95"	9426-9475	1/2"	1/2"
95 1/2"	9476-9525	1/2"	1/2"
96"	9526-9575	1/2"	1/2"
96 1/2"	9576-9625	1/2"	1/2"
97"	9626-9675	1/2"	1/2"
97 1/2"	9676-9725	1/2"	1/2"
98"	9726-9775	1/2"	1/2"
98 1/2"	9776-9825	1/2"	1/2"
99"	9826-9875	1/2"	1/2"
99 1/2"	9876-9925	1/2"	1/2"
100"	9926-9975	1/2"	1/2"
100 1/2"	9976-10025	1/2"	1/2"
101"	10026-10075	1/2"	1/2"
101 1/2"	10076-10125	1/2"	1/2"
102"	10126-10175	1/2"	1/2"
102 1/2"	10176-10225	1/2"	1/2"
103"	10226-10275	1/2"	1/2"
103 1/2"	10276-10325	1/2"	1/2"
104"	10326-10375	1/2"	1/2"
104 1/2"	10376-10425	1/2"	1/2"
105"	10426-10475	1/2"	1/2"
105 1/2"	10476-10525	1/2"	1/2"
106"	10526-10575	1/2"	1/2"
106 1/2"	10576-10625	1/2"	1/2"
107"	10626-10675	1/2"	1/2"
107 1/2"	10676-10725	1/2"	1/2"
108"	10726-10775	1/2"	1/2"
108 1/2"	10776-10825	1/2"	1/2"
109"	10826-10875	1/2"	1/2"
109 1/2"	10876-10925	1/2"	1/2"
110"	10926-10975	1/2"	1/2"
110 1/2"	10976-11025	1/2"	1/2"
111"	11026-11075	1/2"	1/2"
111 1/2"	11076-11125	1/2"	1/2"
112"	11126-11175	1/2"	1/2"
112 1/2"	11176-11225	1/2"	1/2"
113"	11226-11275	1/2"	1/2"
113 1/2"	11276-11325	1/2"	1/2"
114"	11326-11375	1/2"	1/2"
114 1/2"	11376-11425	1/2"	1/2"
115"	11426-11475	1/2"	1/2"
115 1/2"	11476-11525	1/2"	1/2"
116"	11526-11575	1/2"	1/2"
116 1/2"	11576-11625	1/2"	1/2"
117"	11626-11675	1/2"	1/2"
117 1/2"	11676-11725	1/2"	1/2"
118"	11726-11775	1/2"	1/2"
118 1/2"	11776-11825	1/2"	1/2"
119"	11826-11875	1/2"	1/2"
119 1/2"	11876-11925	1/2"	1/2"
120"	11926-11975	1/2"	1/2"
120 1/2"	11976-12025	1/2"	1/2"
121"	12026-12075	1/2"	1/2"
121 1/2"	12076-12125	1/2"	1/2"
122"	12126-12175	1/2"	1/2"
122 1/2"	12176-12225	1/2"	1/2"
123"	12226-12275	1/2"	1/2"
123 1/2"	12276-12325	1/2"	1/2"
124"	12326-12375	1/2"	1/2"
124 1/2"	12376-12425	1/2"	1/2"
125"	12426-12475	1/2"	1/2"
125 1/2"	12476-12525	1/2"	1/2"
126"	12526-12575	1/2"	1/2"
126 1/2"	12576-12625	1/2"	1/2"
127"	12626-12675	1/2"	1/2"
127 1/2"	12676-12725	1/2"	1/2"
128"	12726-12775	1/2"	1/2"
128 1/2"	12776-12825	1/2"	1/2"
129"	12826-12875	1/2"	1/2"
129 1/2"	12876-12925	1/2"	1/2"
130"	12926-12975	1/2"	1/2"
130 1/2"	12976-13025	1/2"	1/2"
131"	13026-13075	1/2"	1/2"
131 1/2"	13076-13125	1/2"	1/2"
132"	13126-13175	1/2"	1/2"



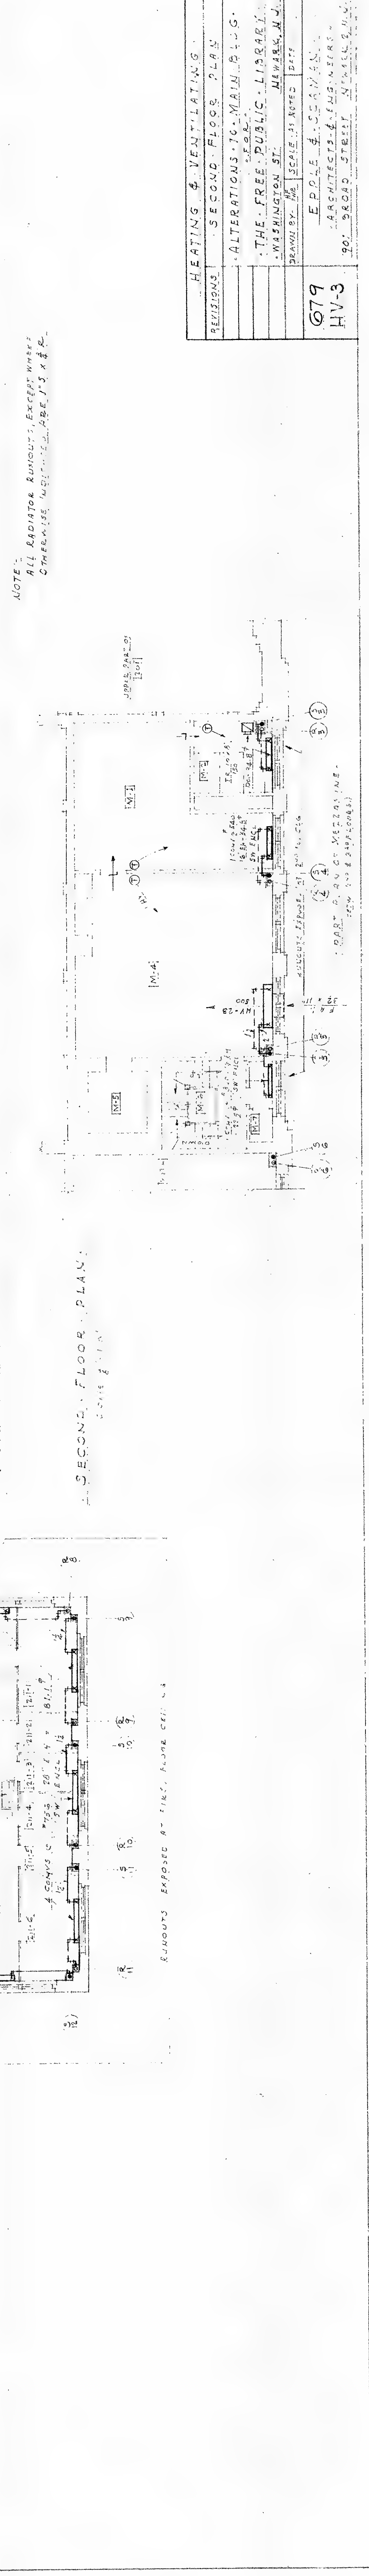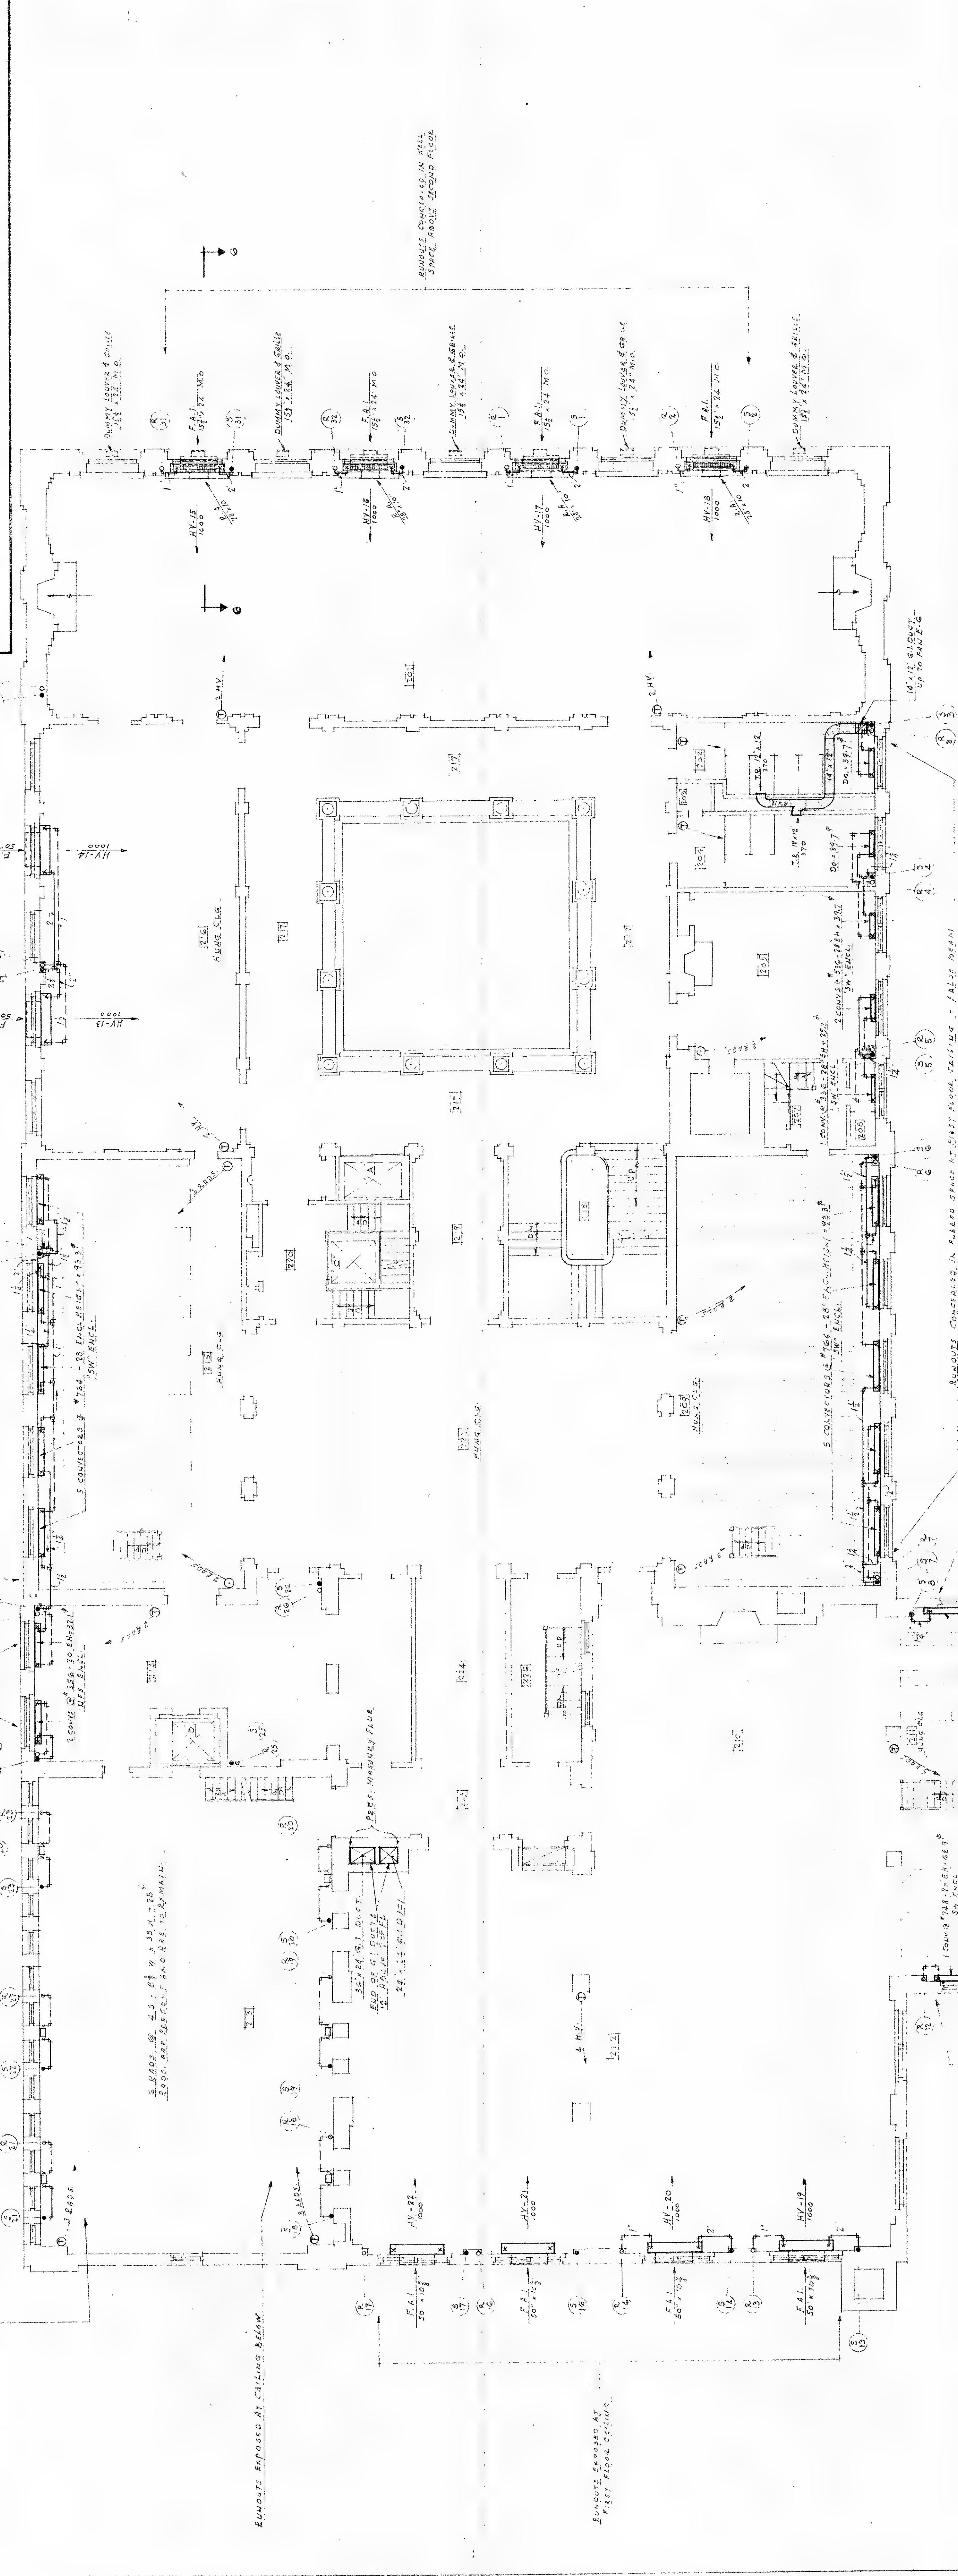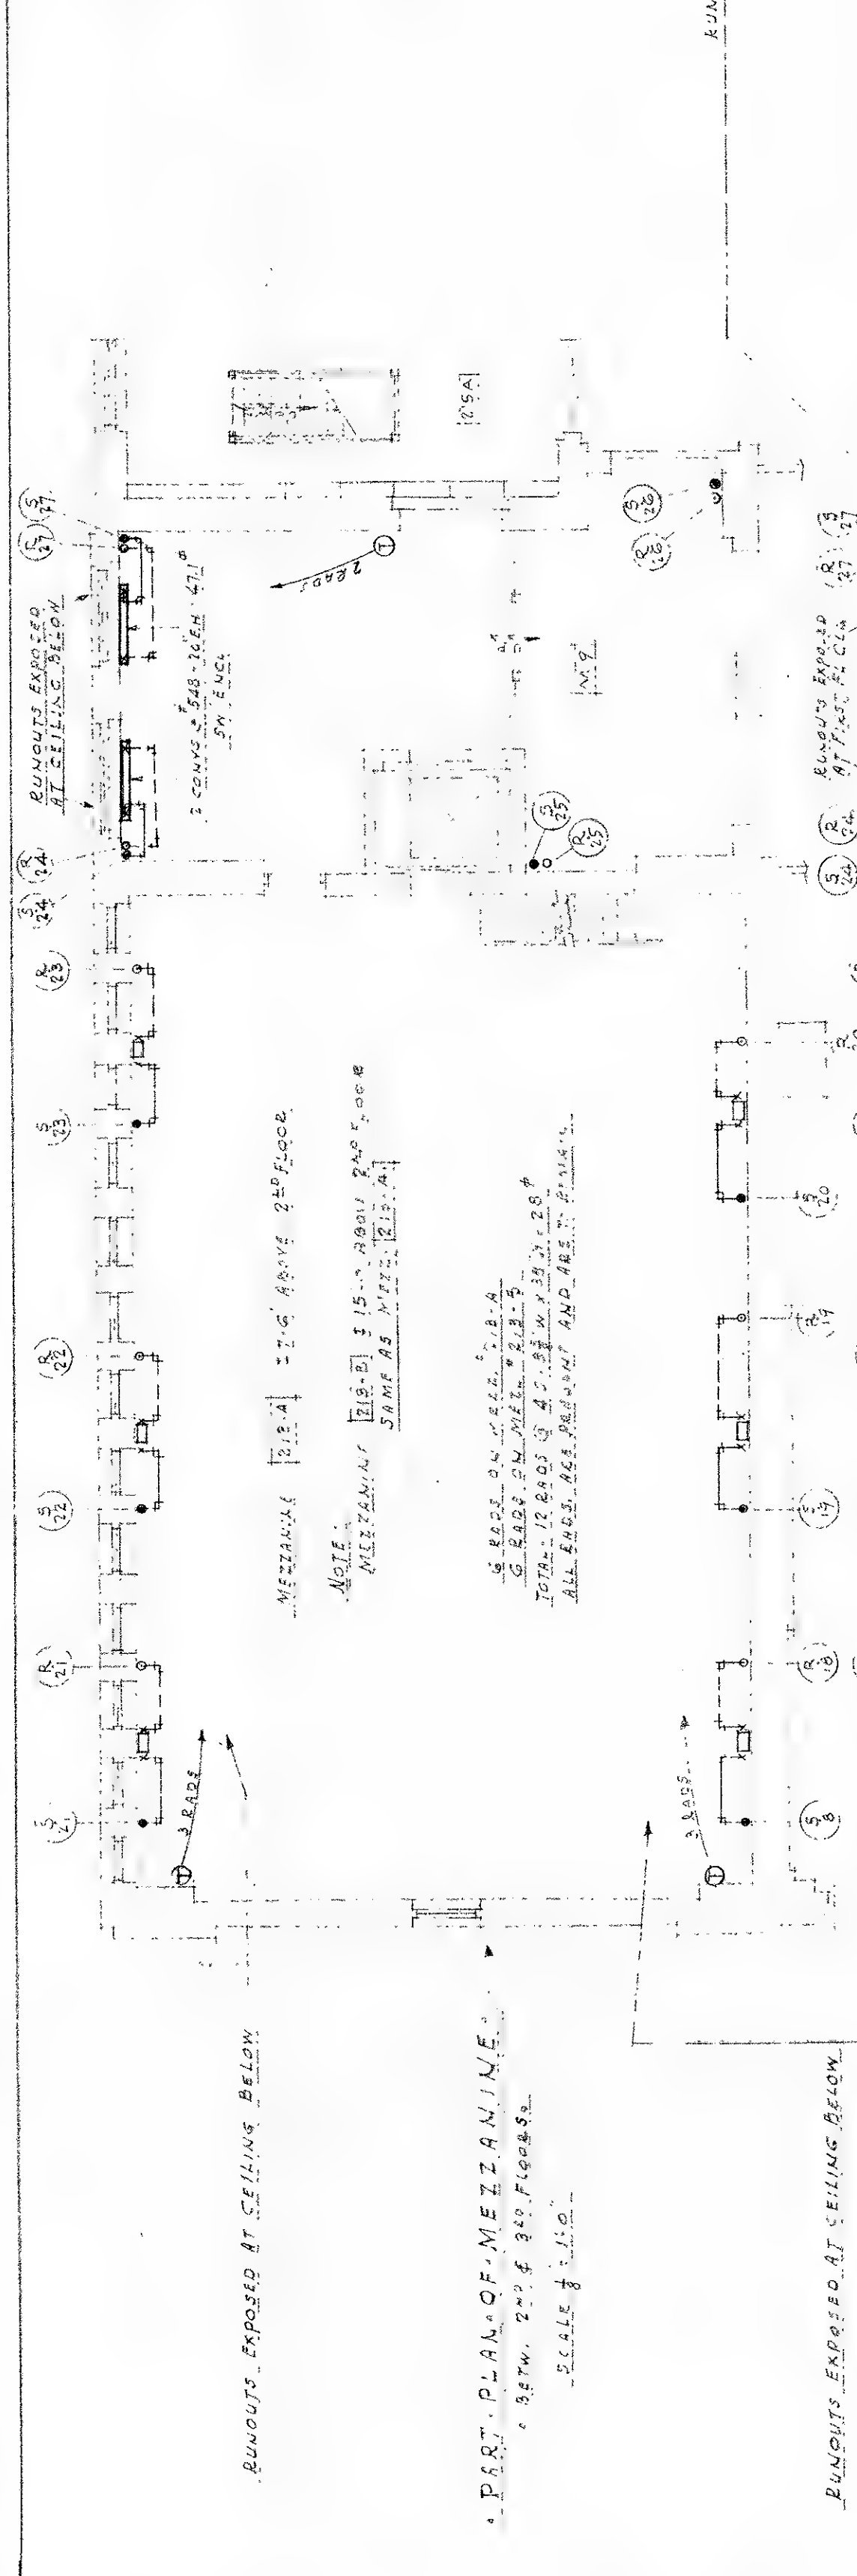



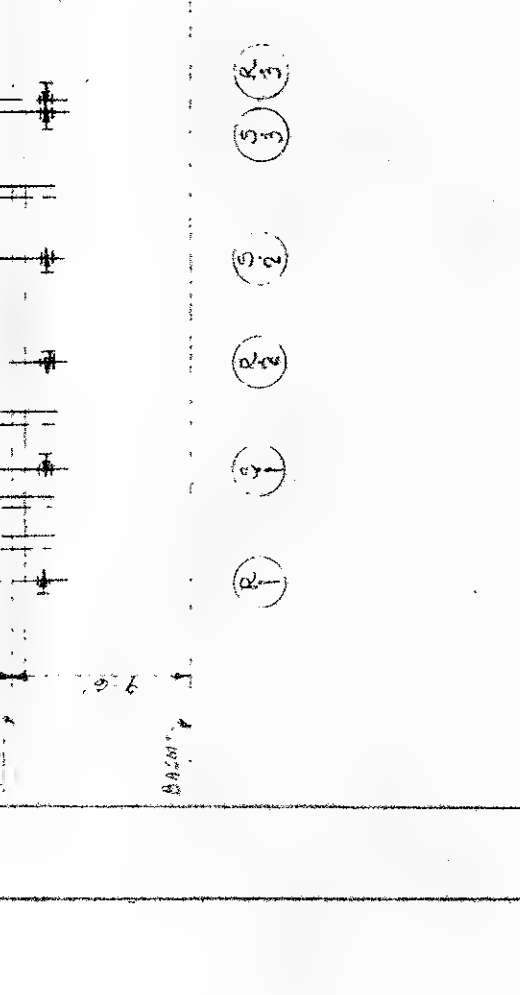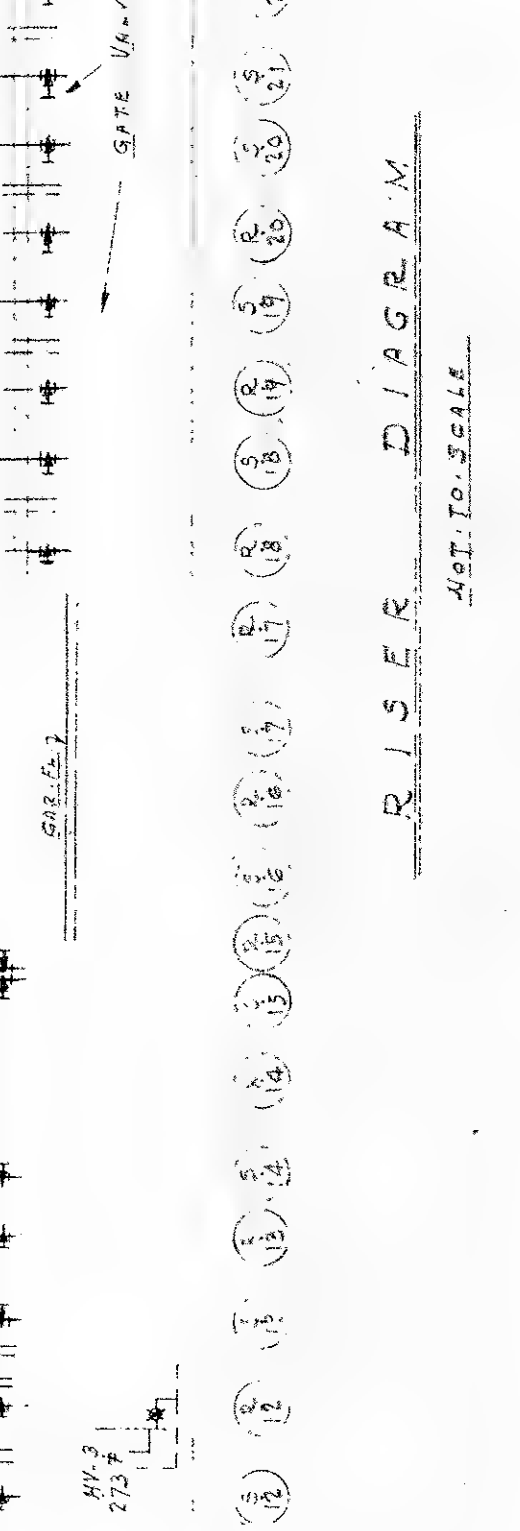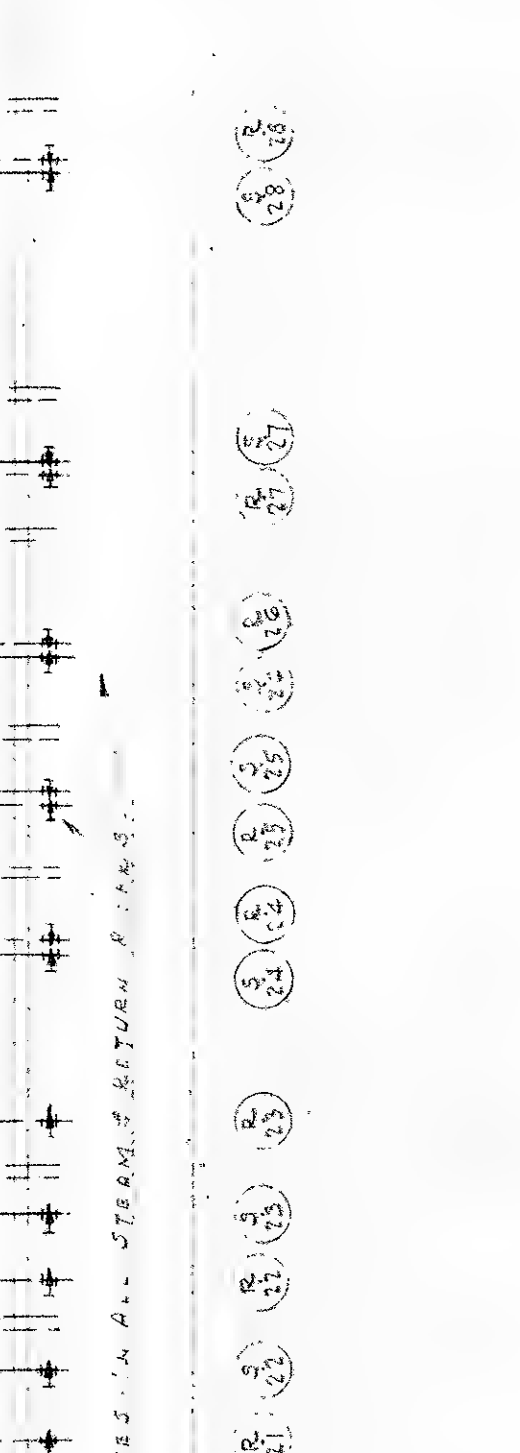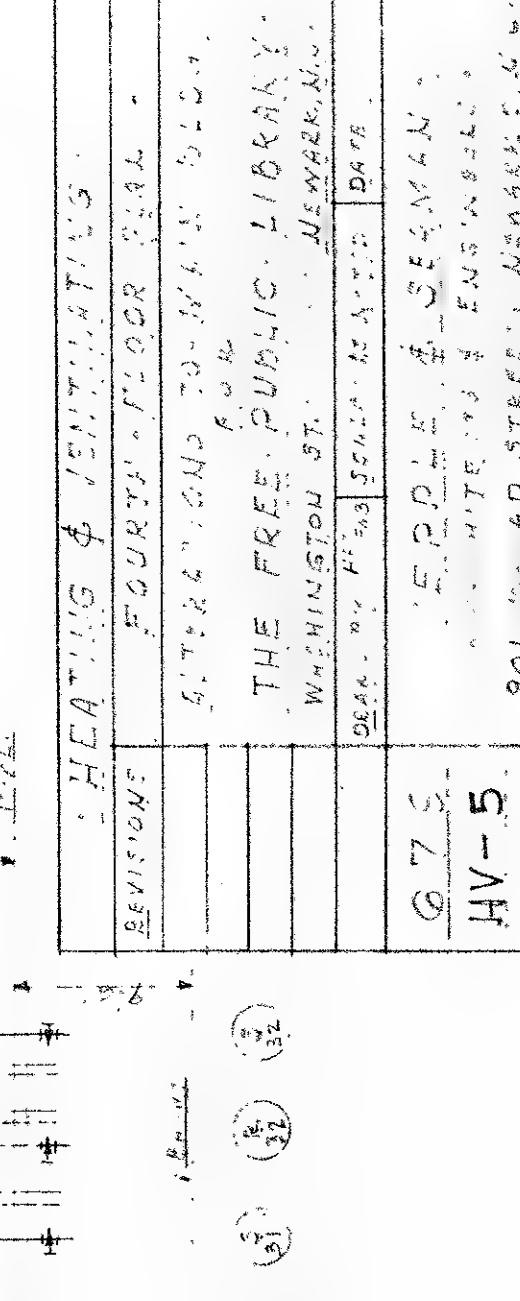









SCHEDULE OF PLUMBING FIXTURES  
(PLATE NUMBERS INDICATED ARE FROM STD. SANITARY CORP. CATALOG)

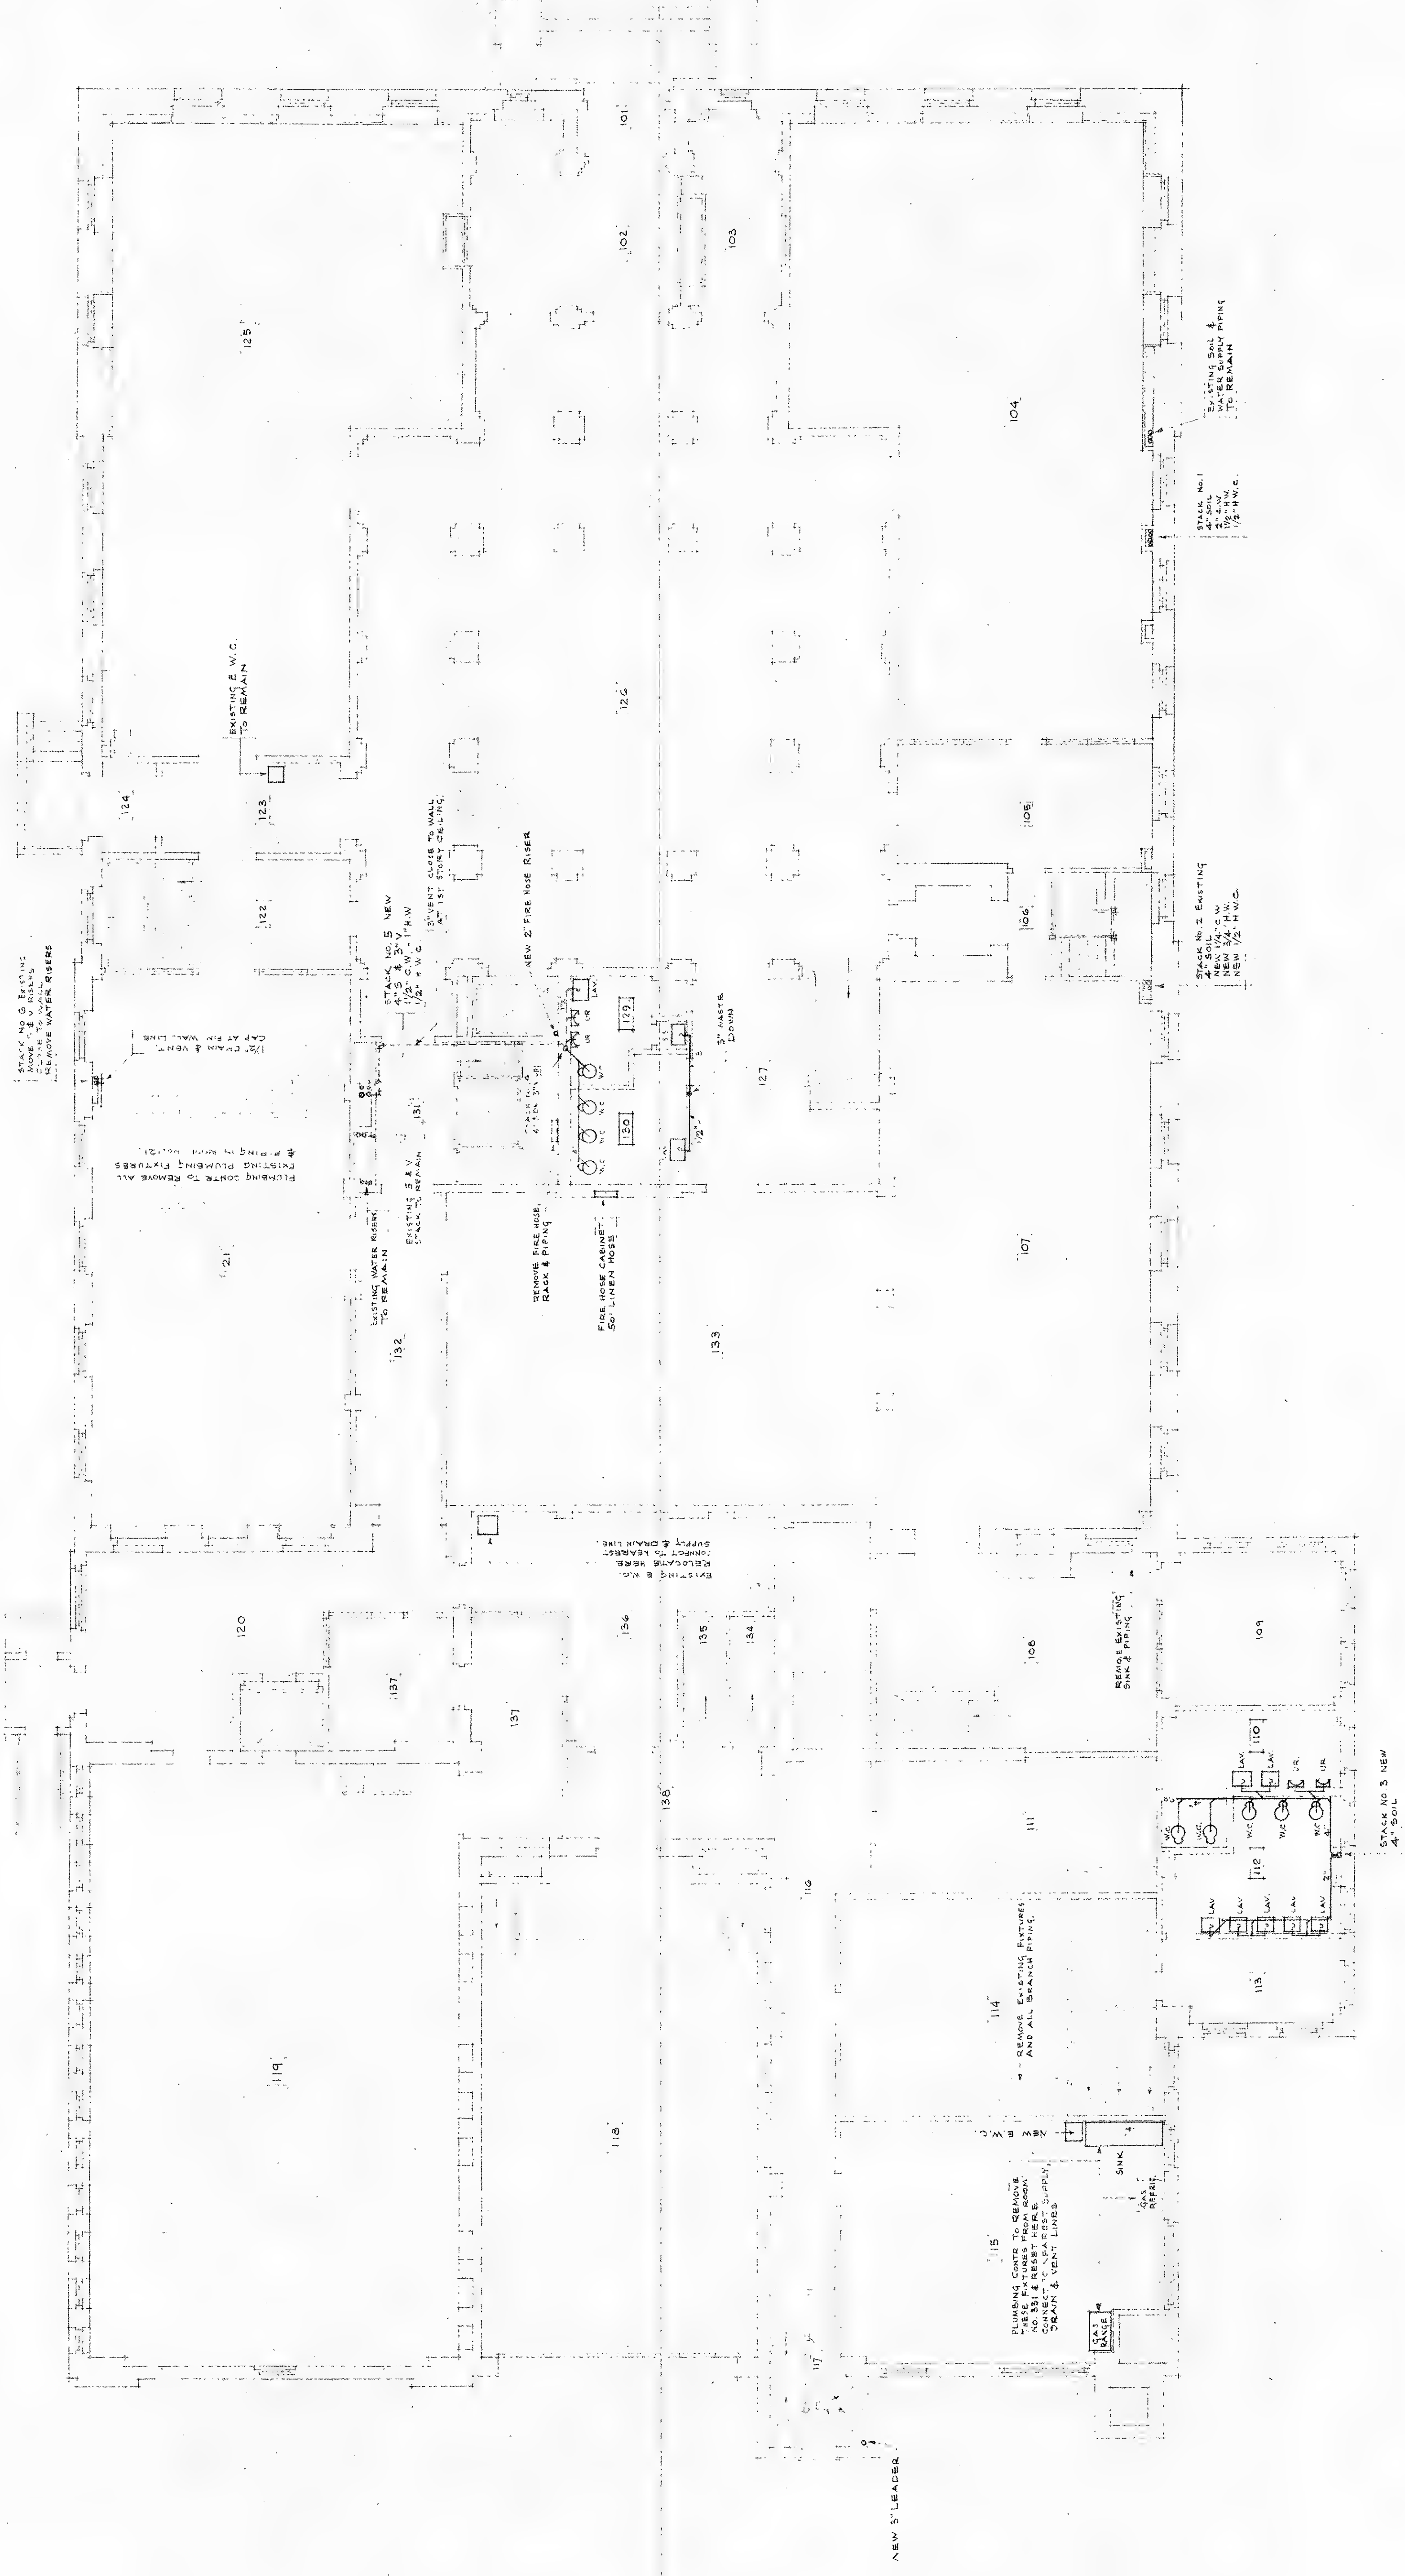
[illegible]

679	REVISIONS	PLUMBING
p2	FIRST FLOOR PLAN	ALTERATIONS TO MAIN BLDG FOR THE FREE PUBLIC LIBRARY WASHINGTON ST. NEWARK, N.J.
	DRAWN BY:	SCALE: 1/8" = 1'-0" DATE:
	EPPLER & SEAMAN	
	ARCHITECTS & ENGINEERS	
	901 BROAD STREET,	NEWARK 2, N. J.



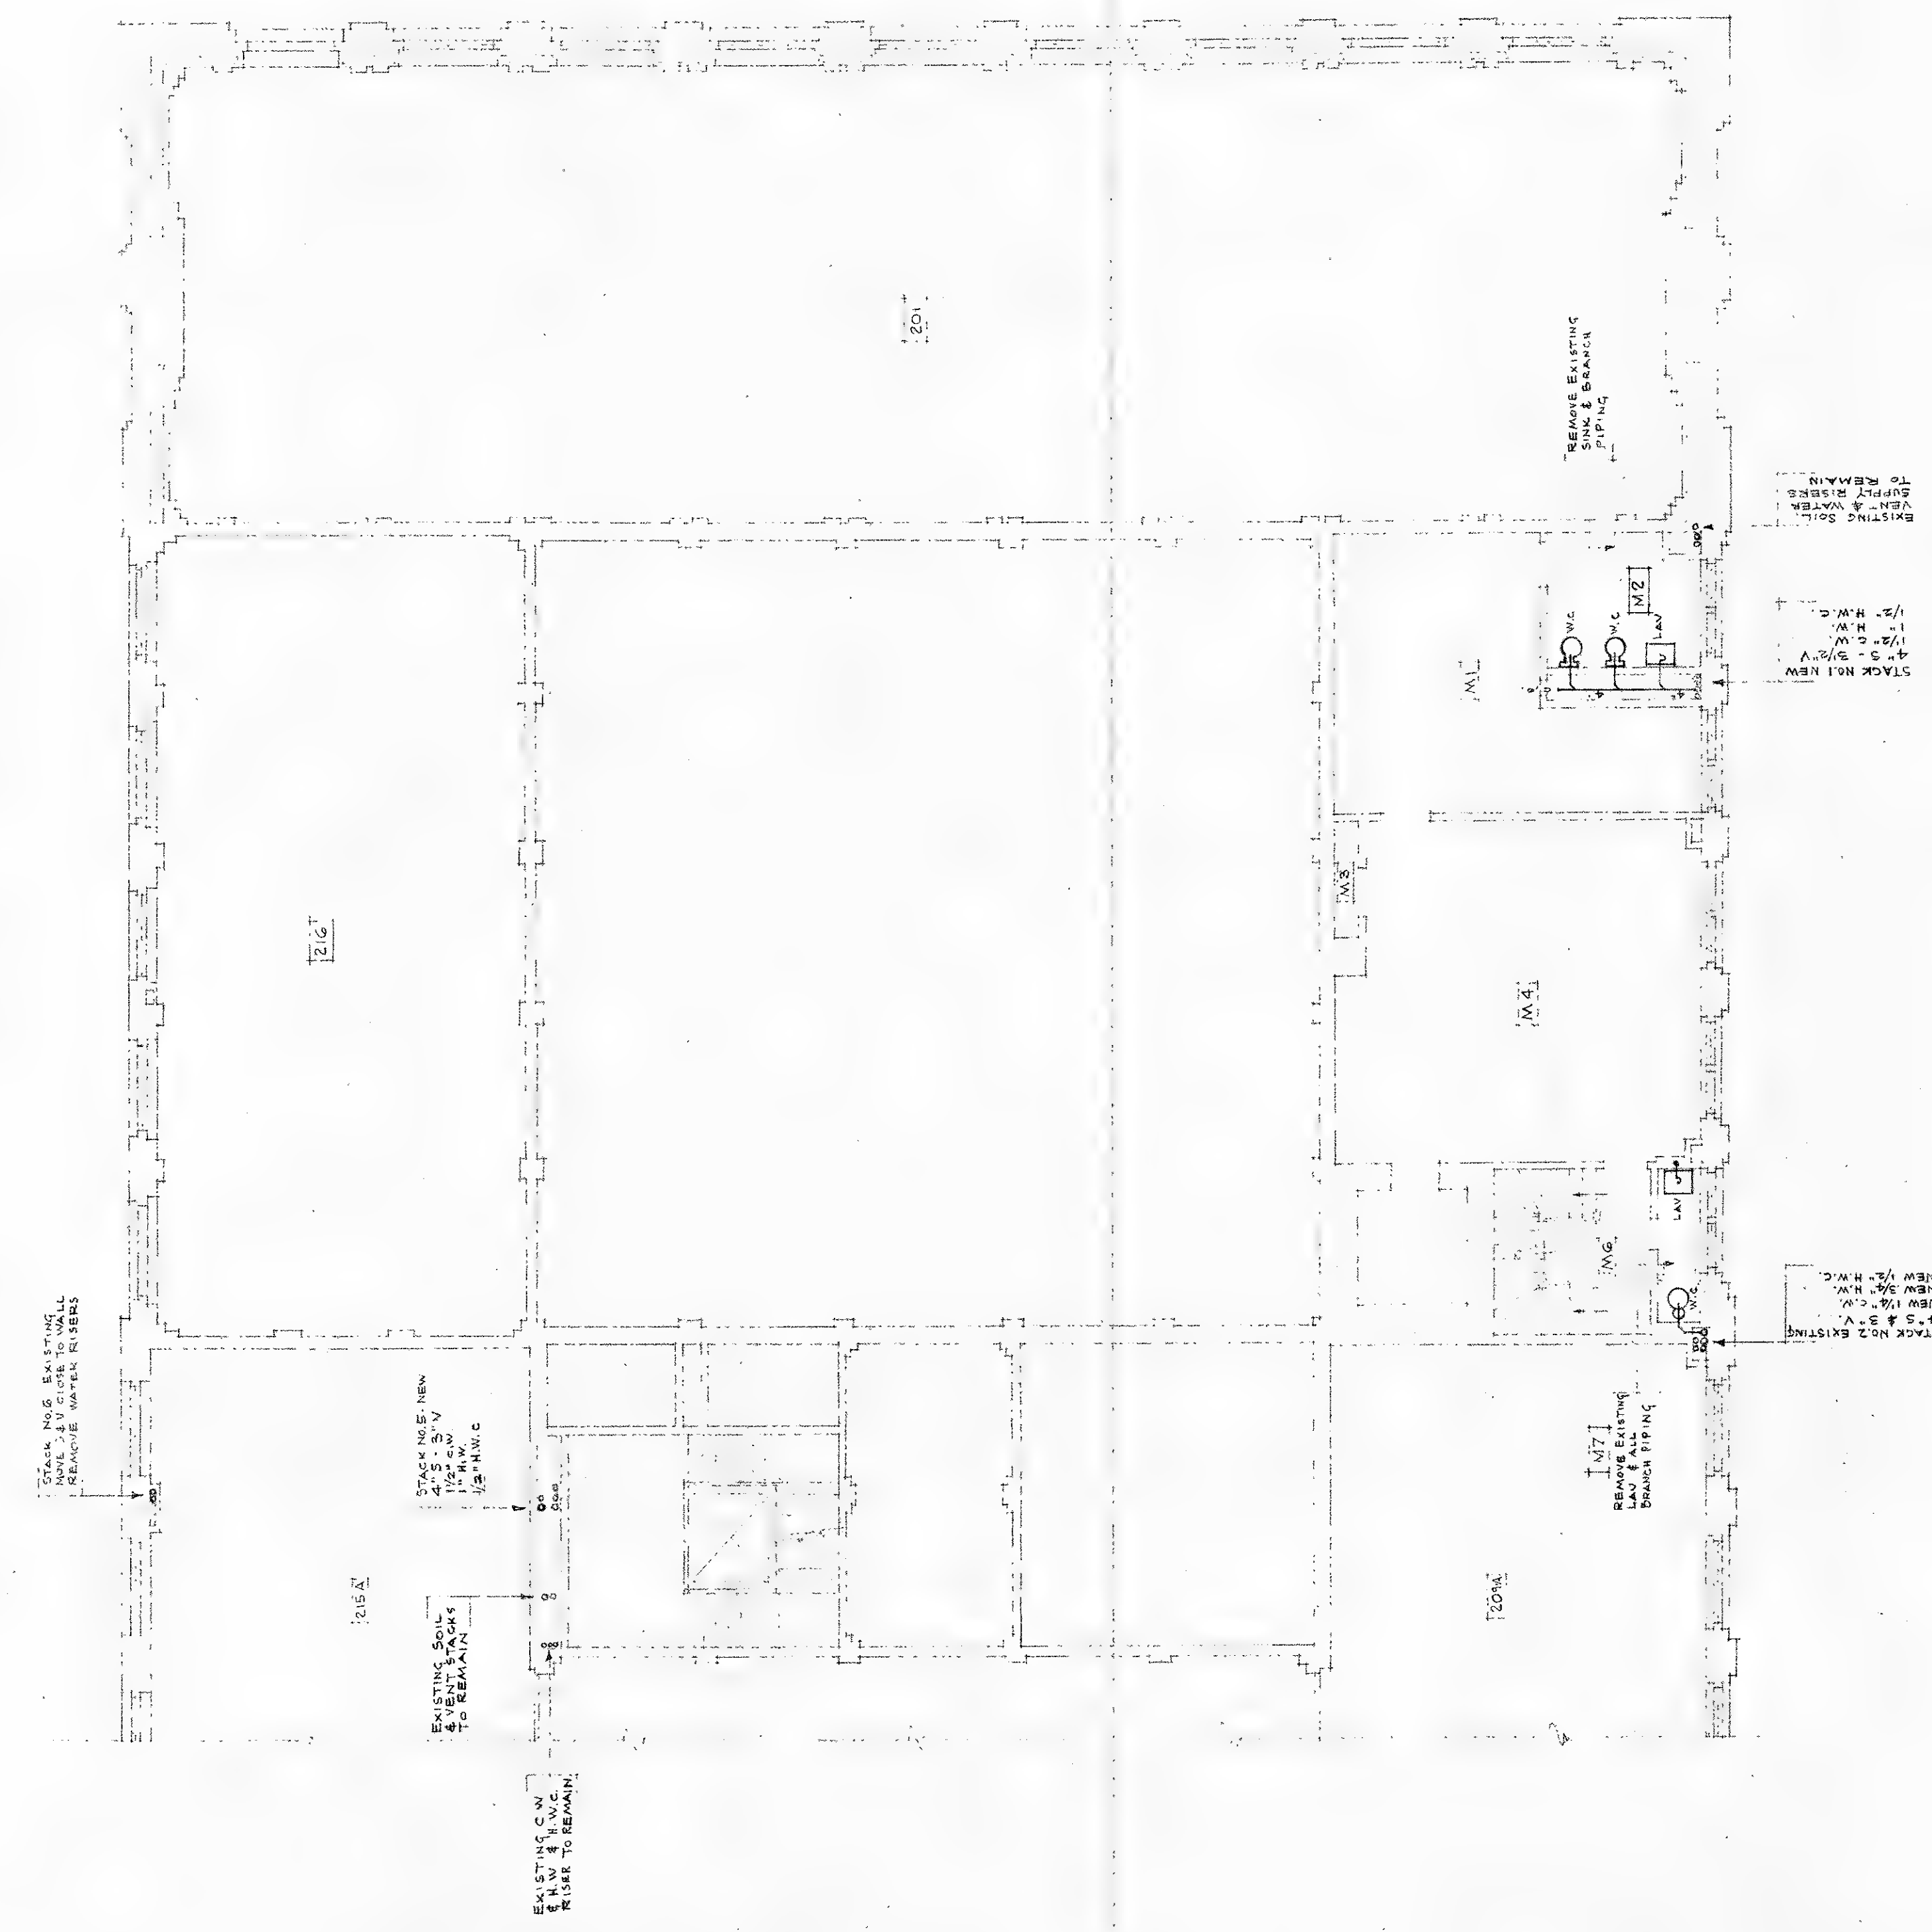



MEZZ FLOOR PLAN

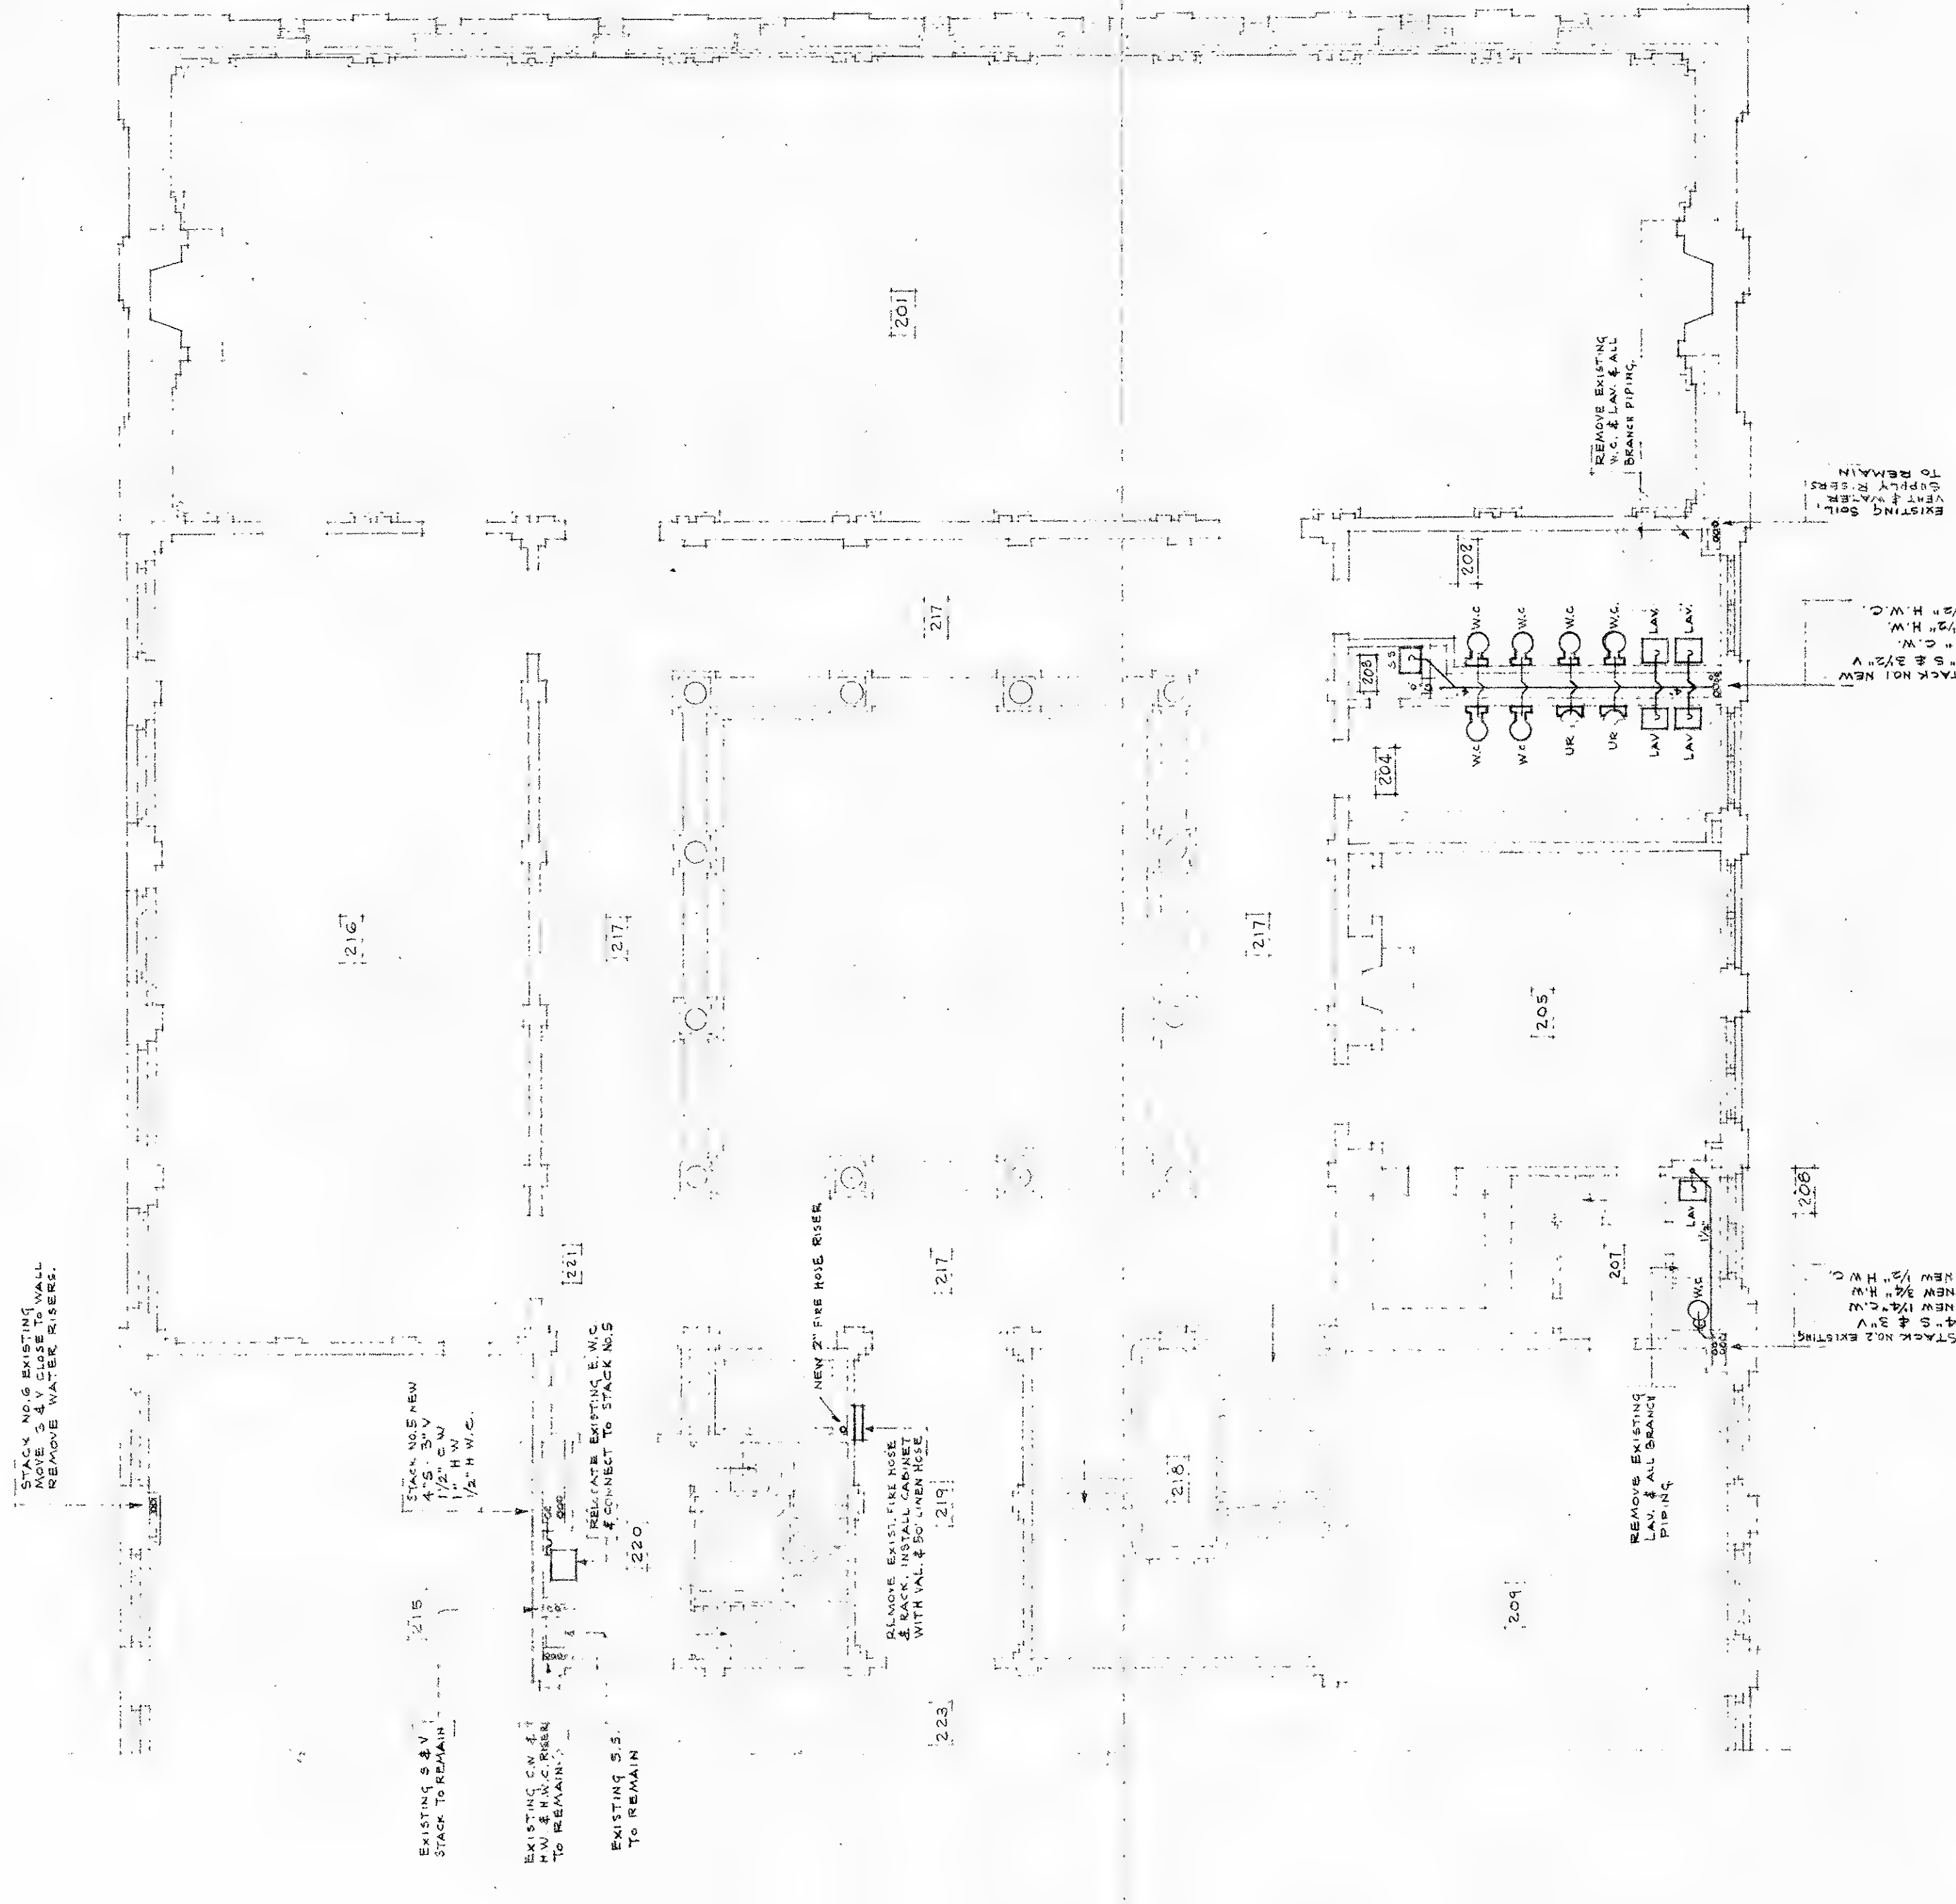

2ND FLOOR PLAN

PLUMBING			
REVISIONS	MEZZANINE & 2ND FLOOR PLANS	PLANS	
	ALTERATIONS TO MAIN BLDG		
	THE FREE PUBLIC LIBRARY		
	WASHINGTON ST. NEWARK, N. J.		
679	DATE	SCALE: 1/8" = 1'-0"	
P.3	EPPLER & SEAMAN		
	ARCHITECTS & ENGINEERS		
	901 BROAD STREET, NEWARK 2, N. J.		




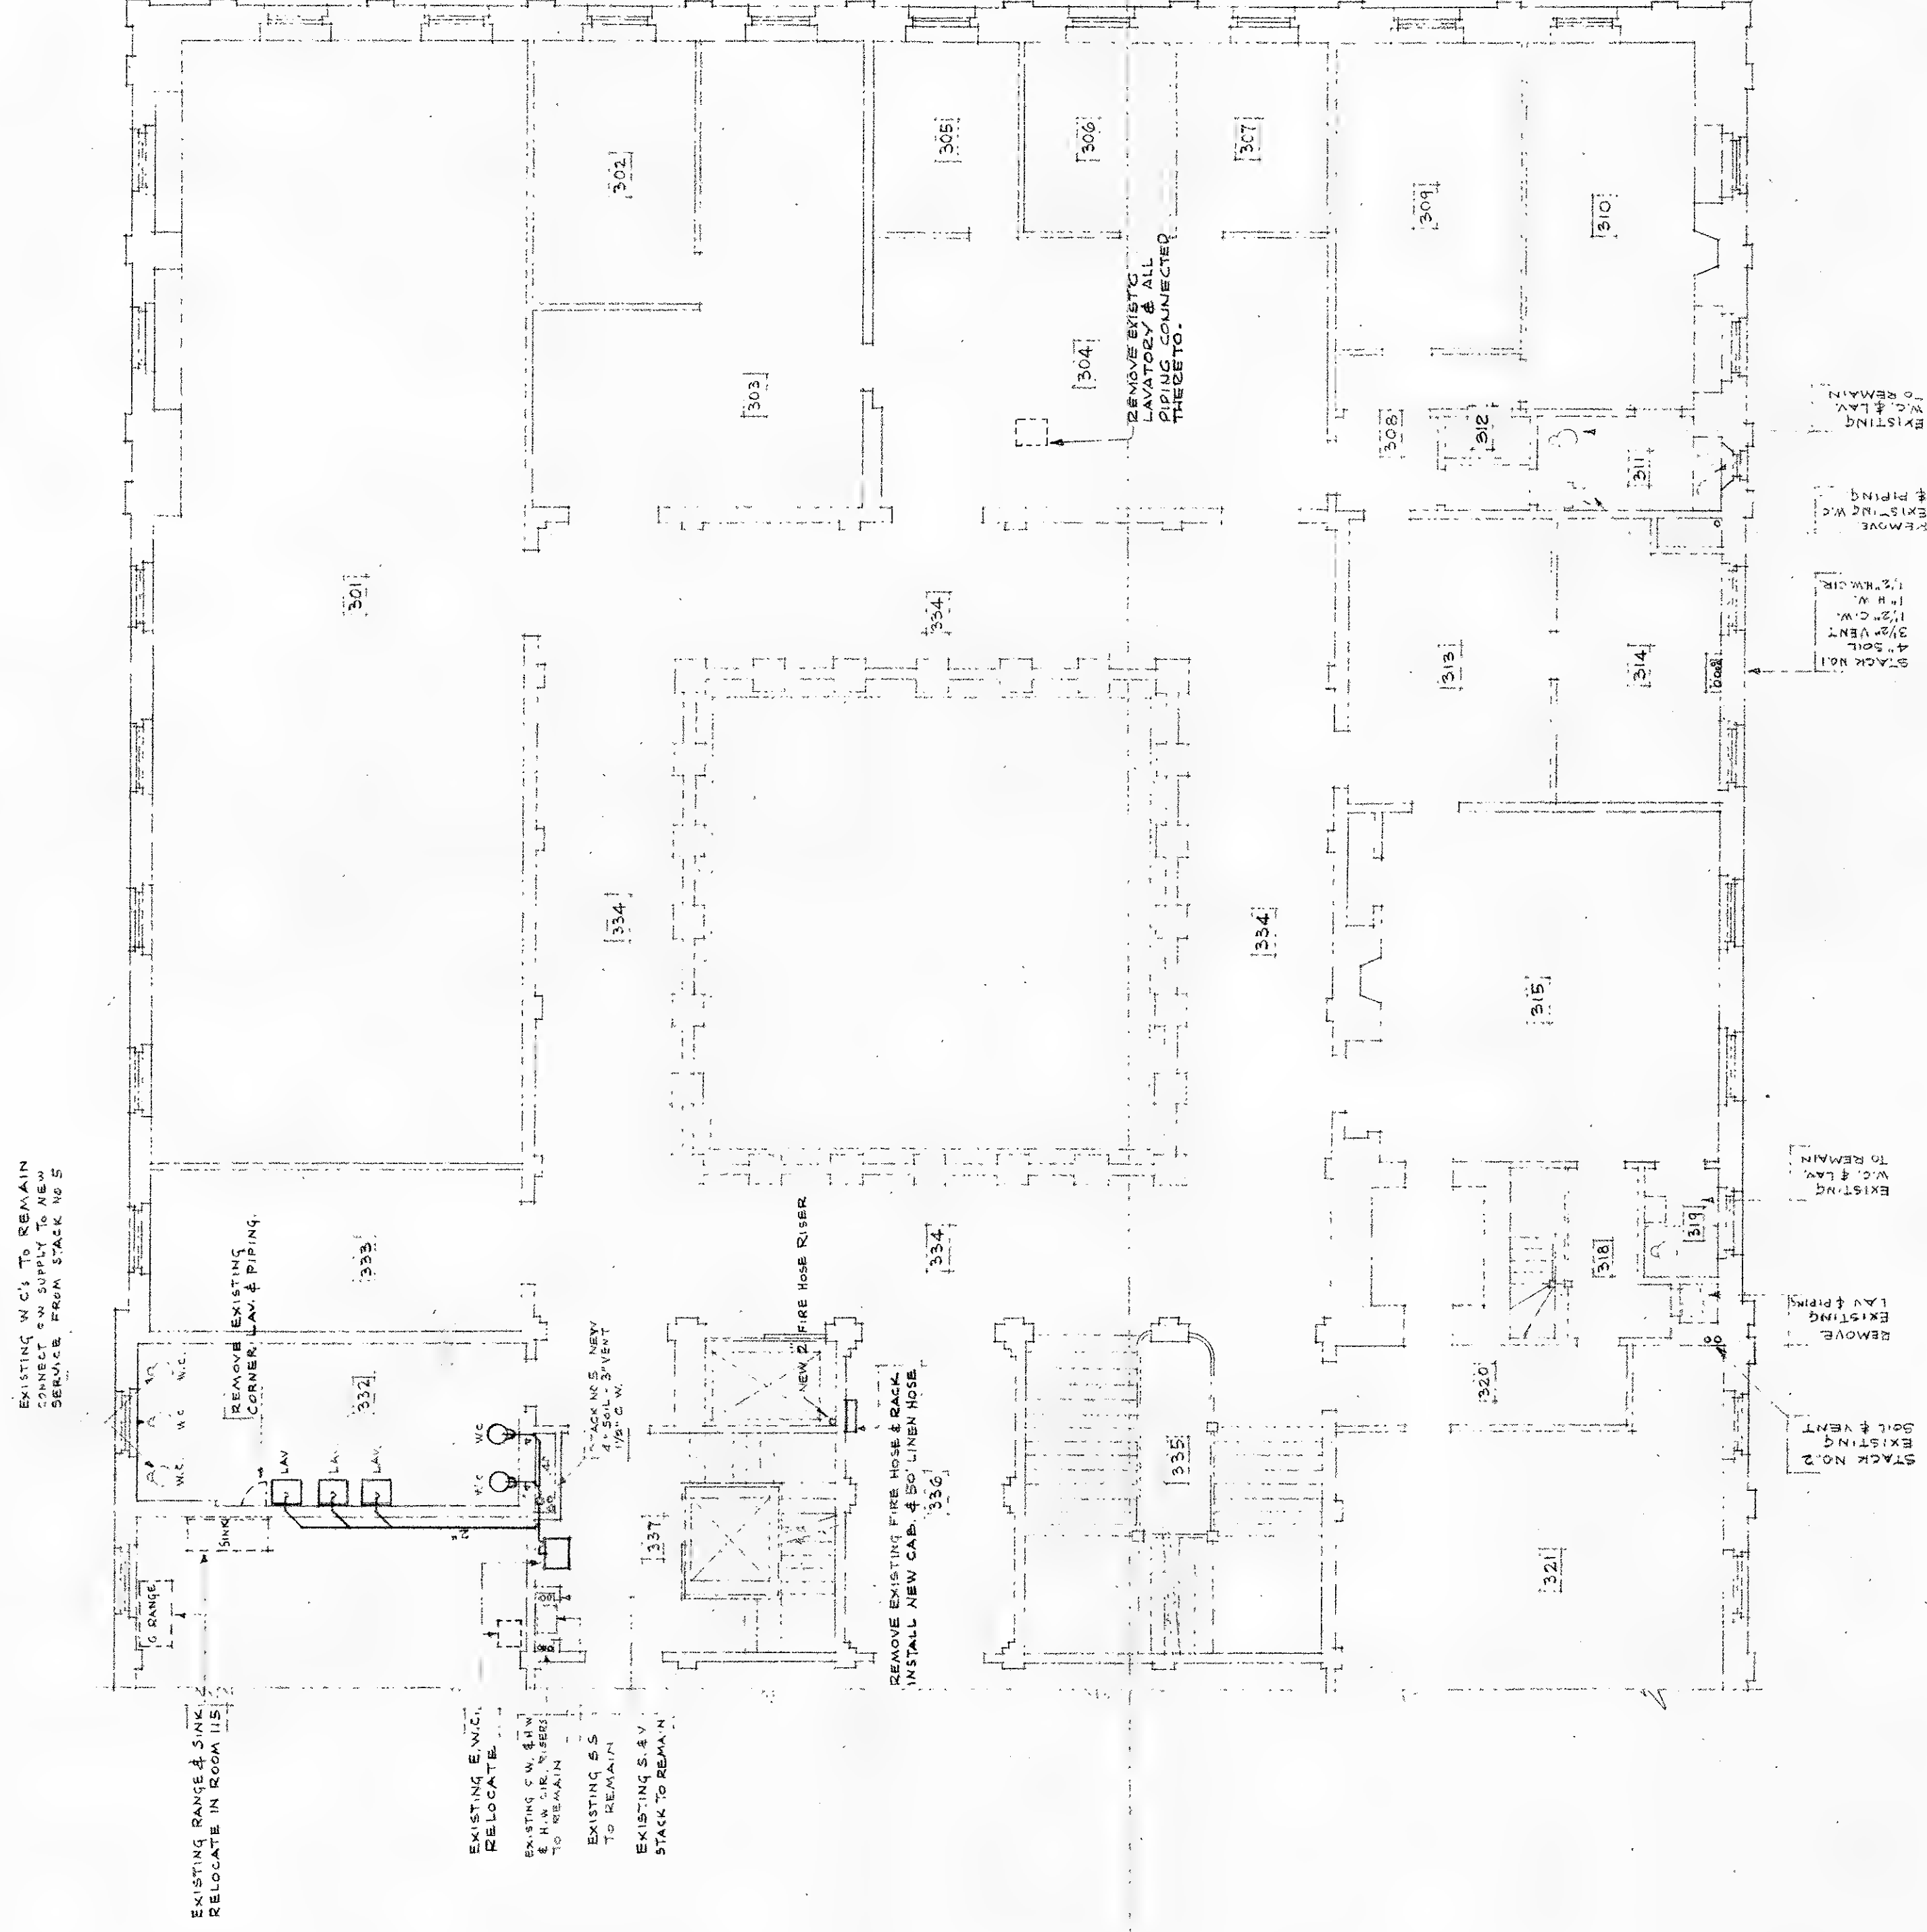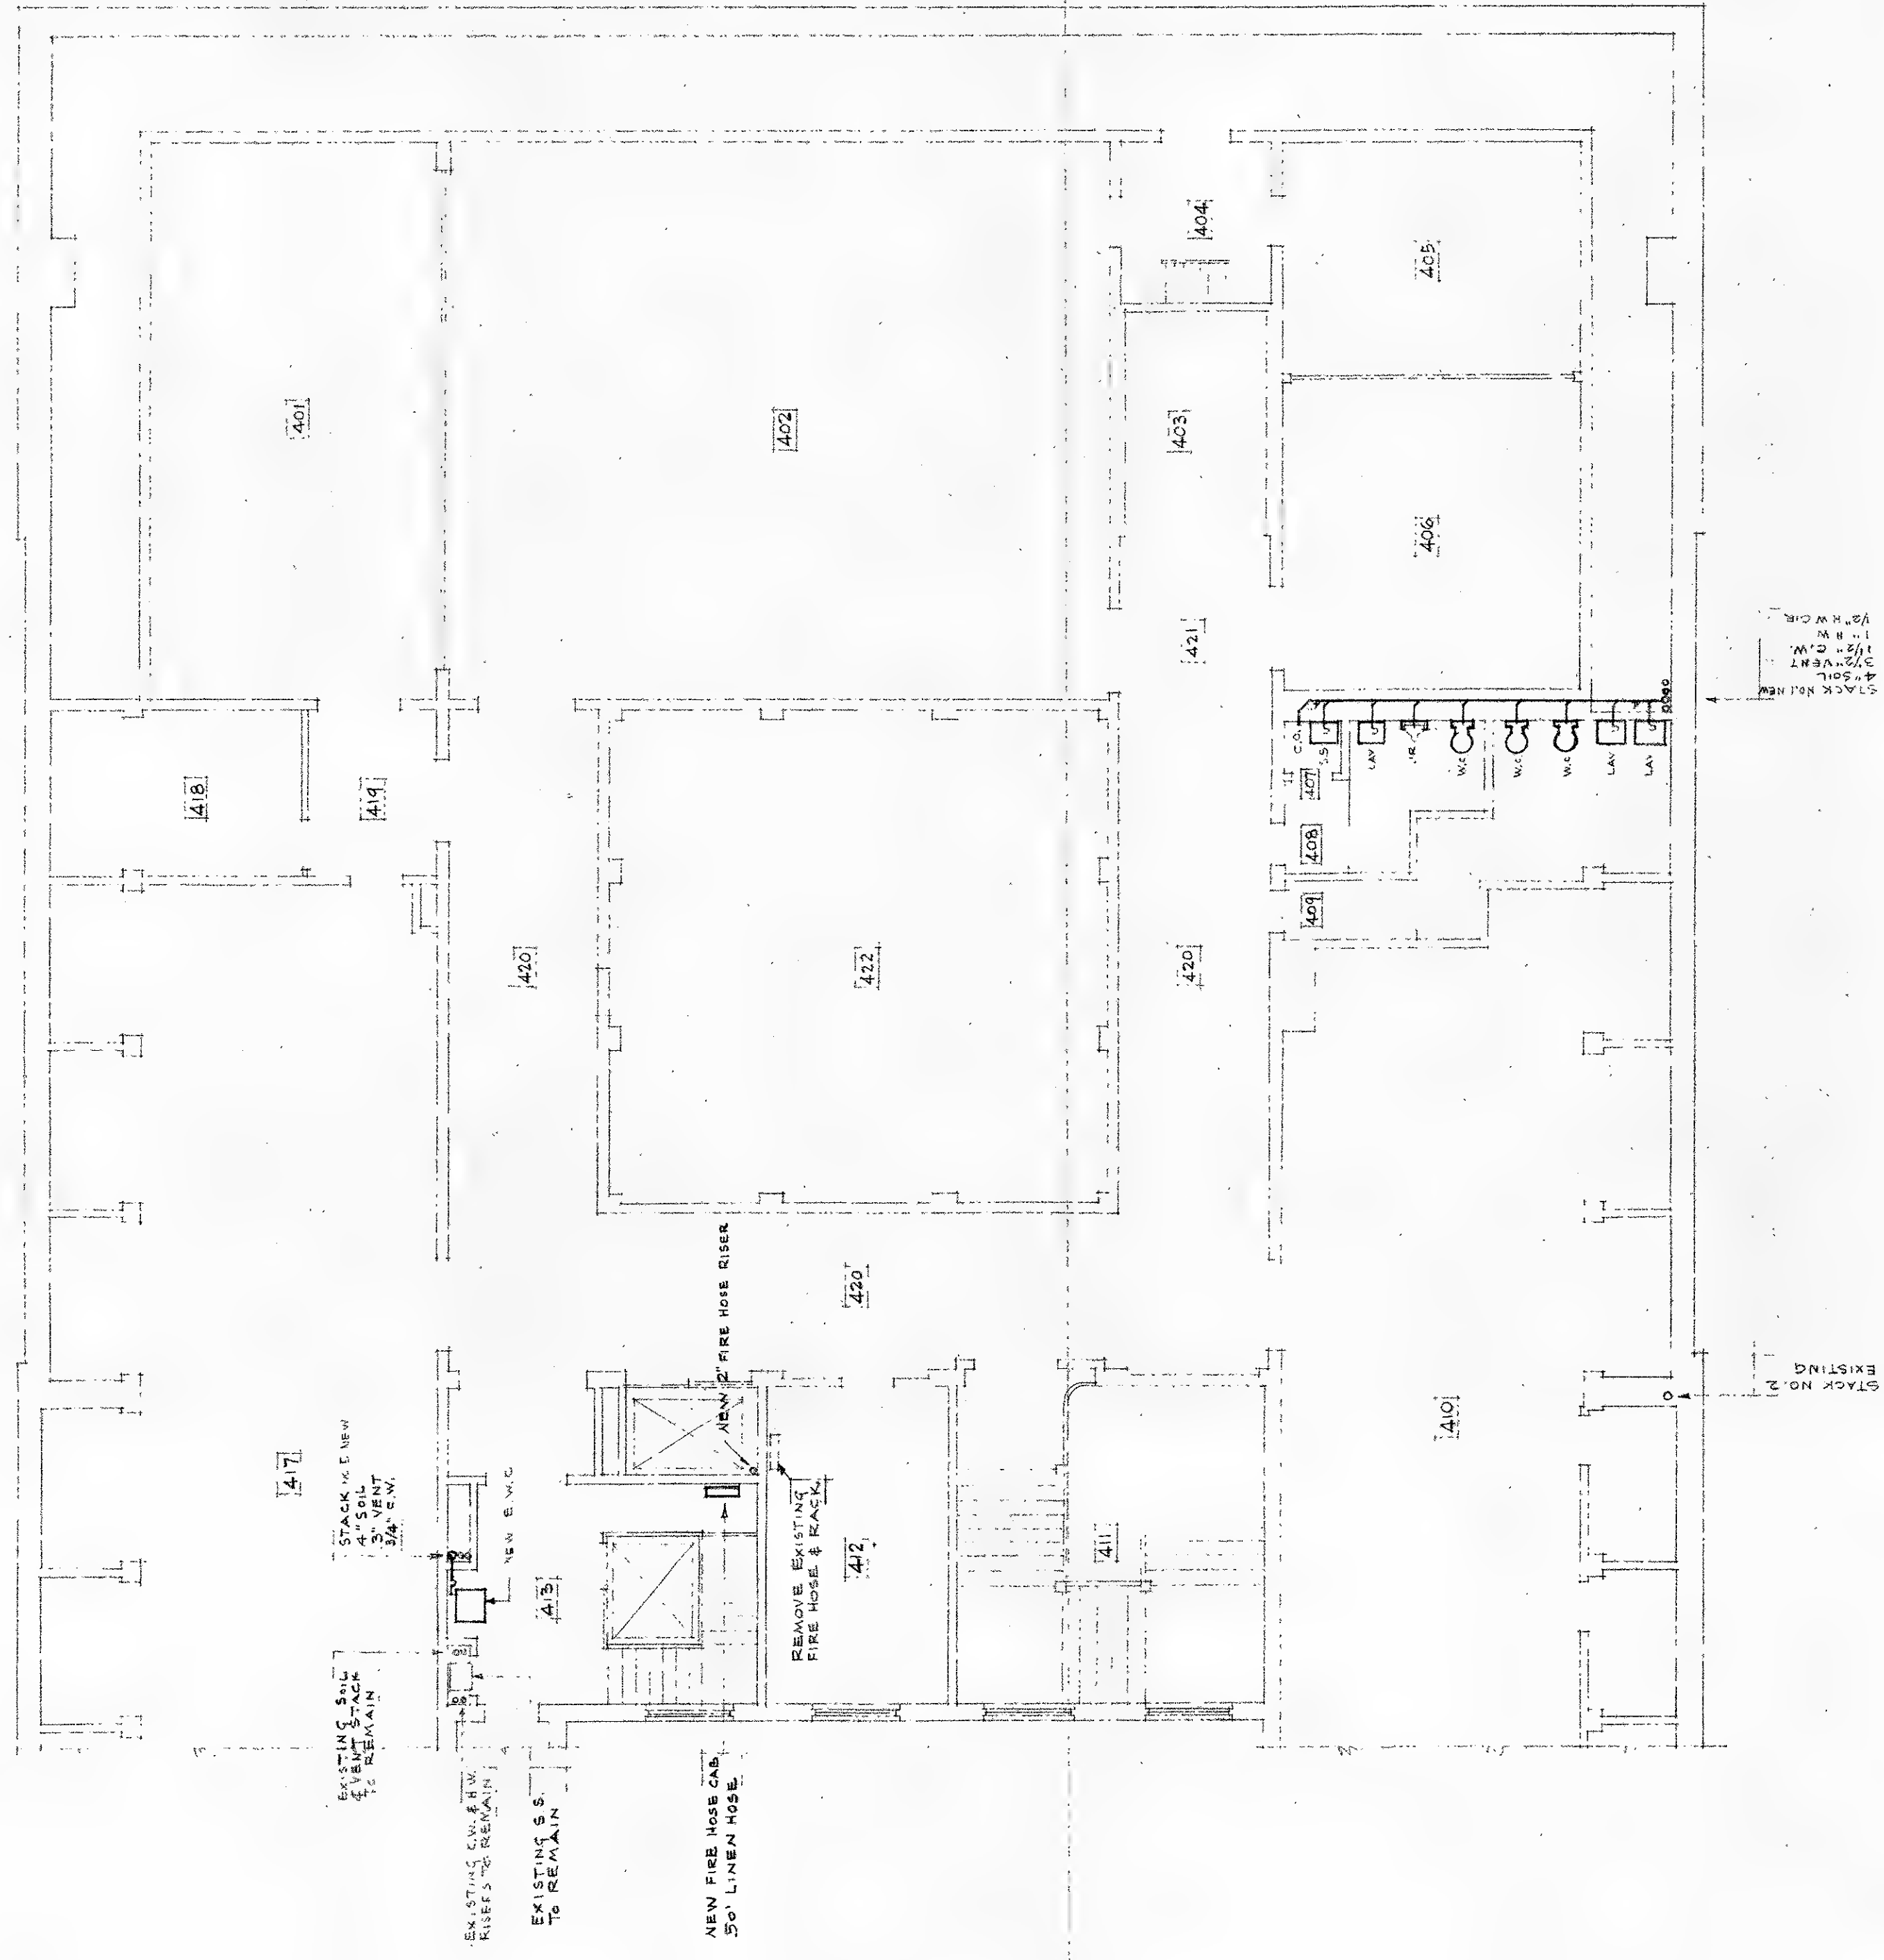

NOTE - ROOMS 325 & 326 NOT SHOWN ON THIS PLAN.  
PLUMBING CONTR. SHALL REMOVE FROM EACH  
ROOM, ONE SINK & ALL EXPOSED CONNECTED PIPE

REVISIONS	<p><b>P L U M B I N G</b></p> <p>SBD 3-4TH FLOOR PLANS</p> <p>ALTERATIONS TO MAIN BLDG FOR</p> <p>THE EDGE PUBLIC LIBRARY</p> <p>WASHINGTON ST. NEWBURGH, N. J.</p>	
	DRAWN BY:	SCALE: 1/8" = 1'-0"
		DATE:
679	<p><b>APPLE &amp; SEAMAN</b></p> <p>ARCHITECTS &amp; ENGINEERS</p> <p>901 BROAD STREET, NEWARK 2, N. J.</p>	
P4		



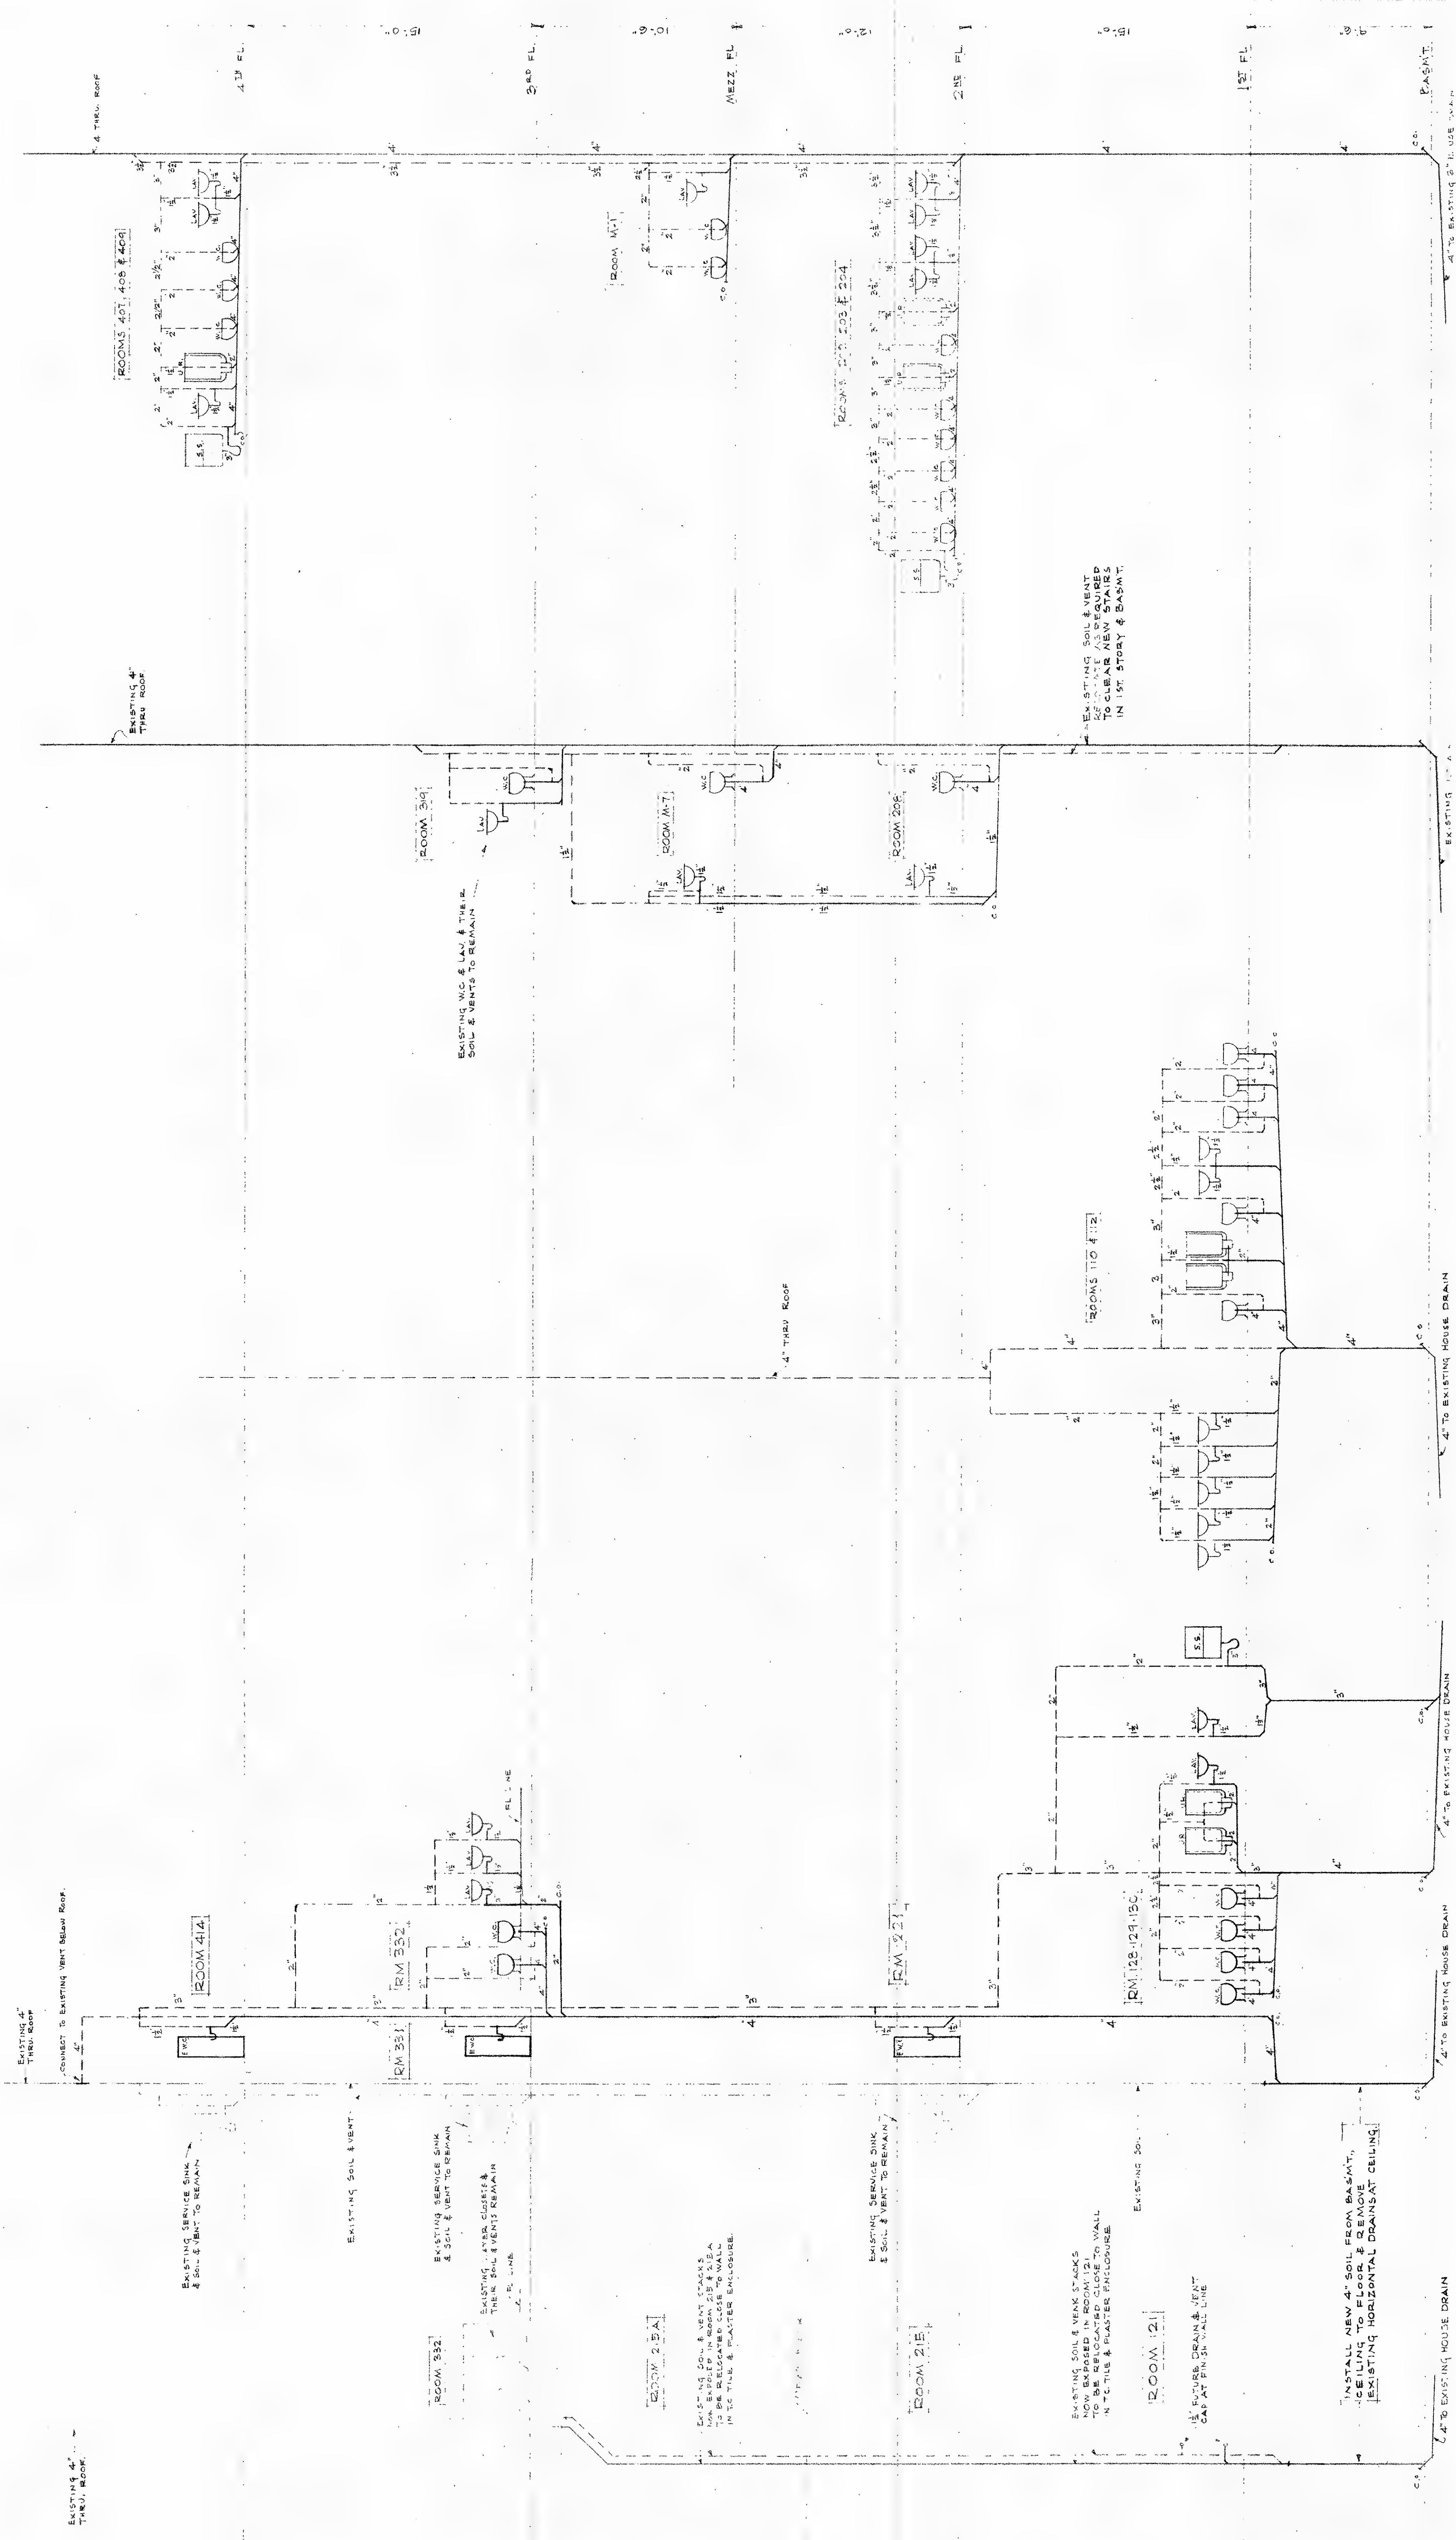

STACK NO. 1

STACK NO. 2

STACK NO. 3

STACK NO. 4

STACK NO. 5

STACK NO. 6



PLUMBING			
REVISIONS	DATE	BY	SCALE
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3	10/1/2020	EP	1/8" = 1'-0"
4	10/1/2020	EP	1/8" = 1'-0"
5	10/1/2020	EP	1/8" = 1'-0"
6	10/1/2020	EP	1/8" = 1'-0"
7	10/1/2020	EP	1/8" = 1'-0"
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98	10/1/2020	EP	1/8" = 1'-0"
99	10/1/2020	EP	1/8" = 1'-0"
100	10/1/2020	EP	1/8" = 1'-0"

679  
P-5

EPPL & SEAMAN  
ARCHITECTS & ENGINEERS  
901 BROAD STREET NEWARK 2 N J



M/F R	M/F R		CHILLED WATER CAPACITY						CONDENSER WATER CAPACITY					
	NO.	DATE	SPM	TEMP	TRAP	TD	GEPA	TEMP	TRAP	TD	GEPA	TEMP	TRAP	TD
ACME INDUSTRY	416-20		20	53	44	150	52	95	85	108				
NO. 1 CONDENSING TOWER - 100% COOL NO. 2 REFRIGERANT TOWER - 100% NO. 3 REFRIGERANT TOWER - 100% NO. 4 REFRIGERANT TOWER - 100%														

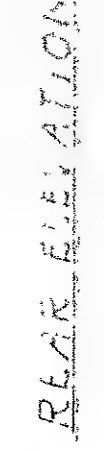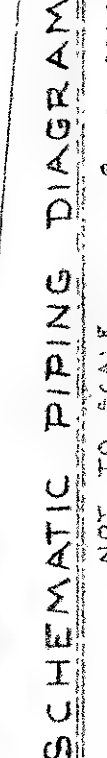


"AIR CONDITIONING"  
RAVENS  
FOURTH FLOOR PLAN  
- ATELA 315 - 2ND MAIN BLDG.  
THE FREE PUBLIC LIBRARY  
WASHINGTON ST.  
UNIVERSITY OF SCIENCE & ARTS  
DENTON 11000  
APPLE & SEAMAN  
ARCHITECTS & ENGINEERS  
301 BROAD STREET NEWARK 2 N.J.

NOTE:

1. THE OPERATING SYSTEM, POWER, PRESSURE, IS  
CONTAINED IN SECTION 1, CELL 10, 11, 12, 840,




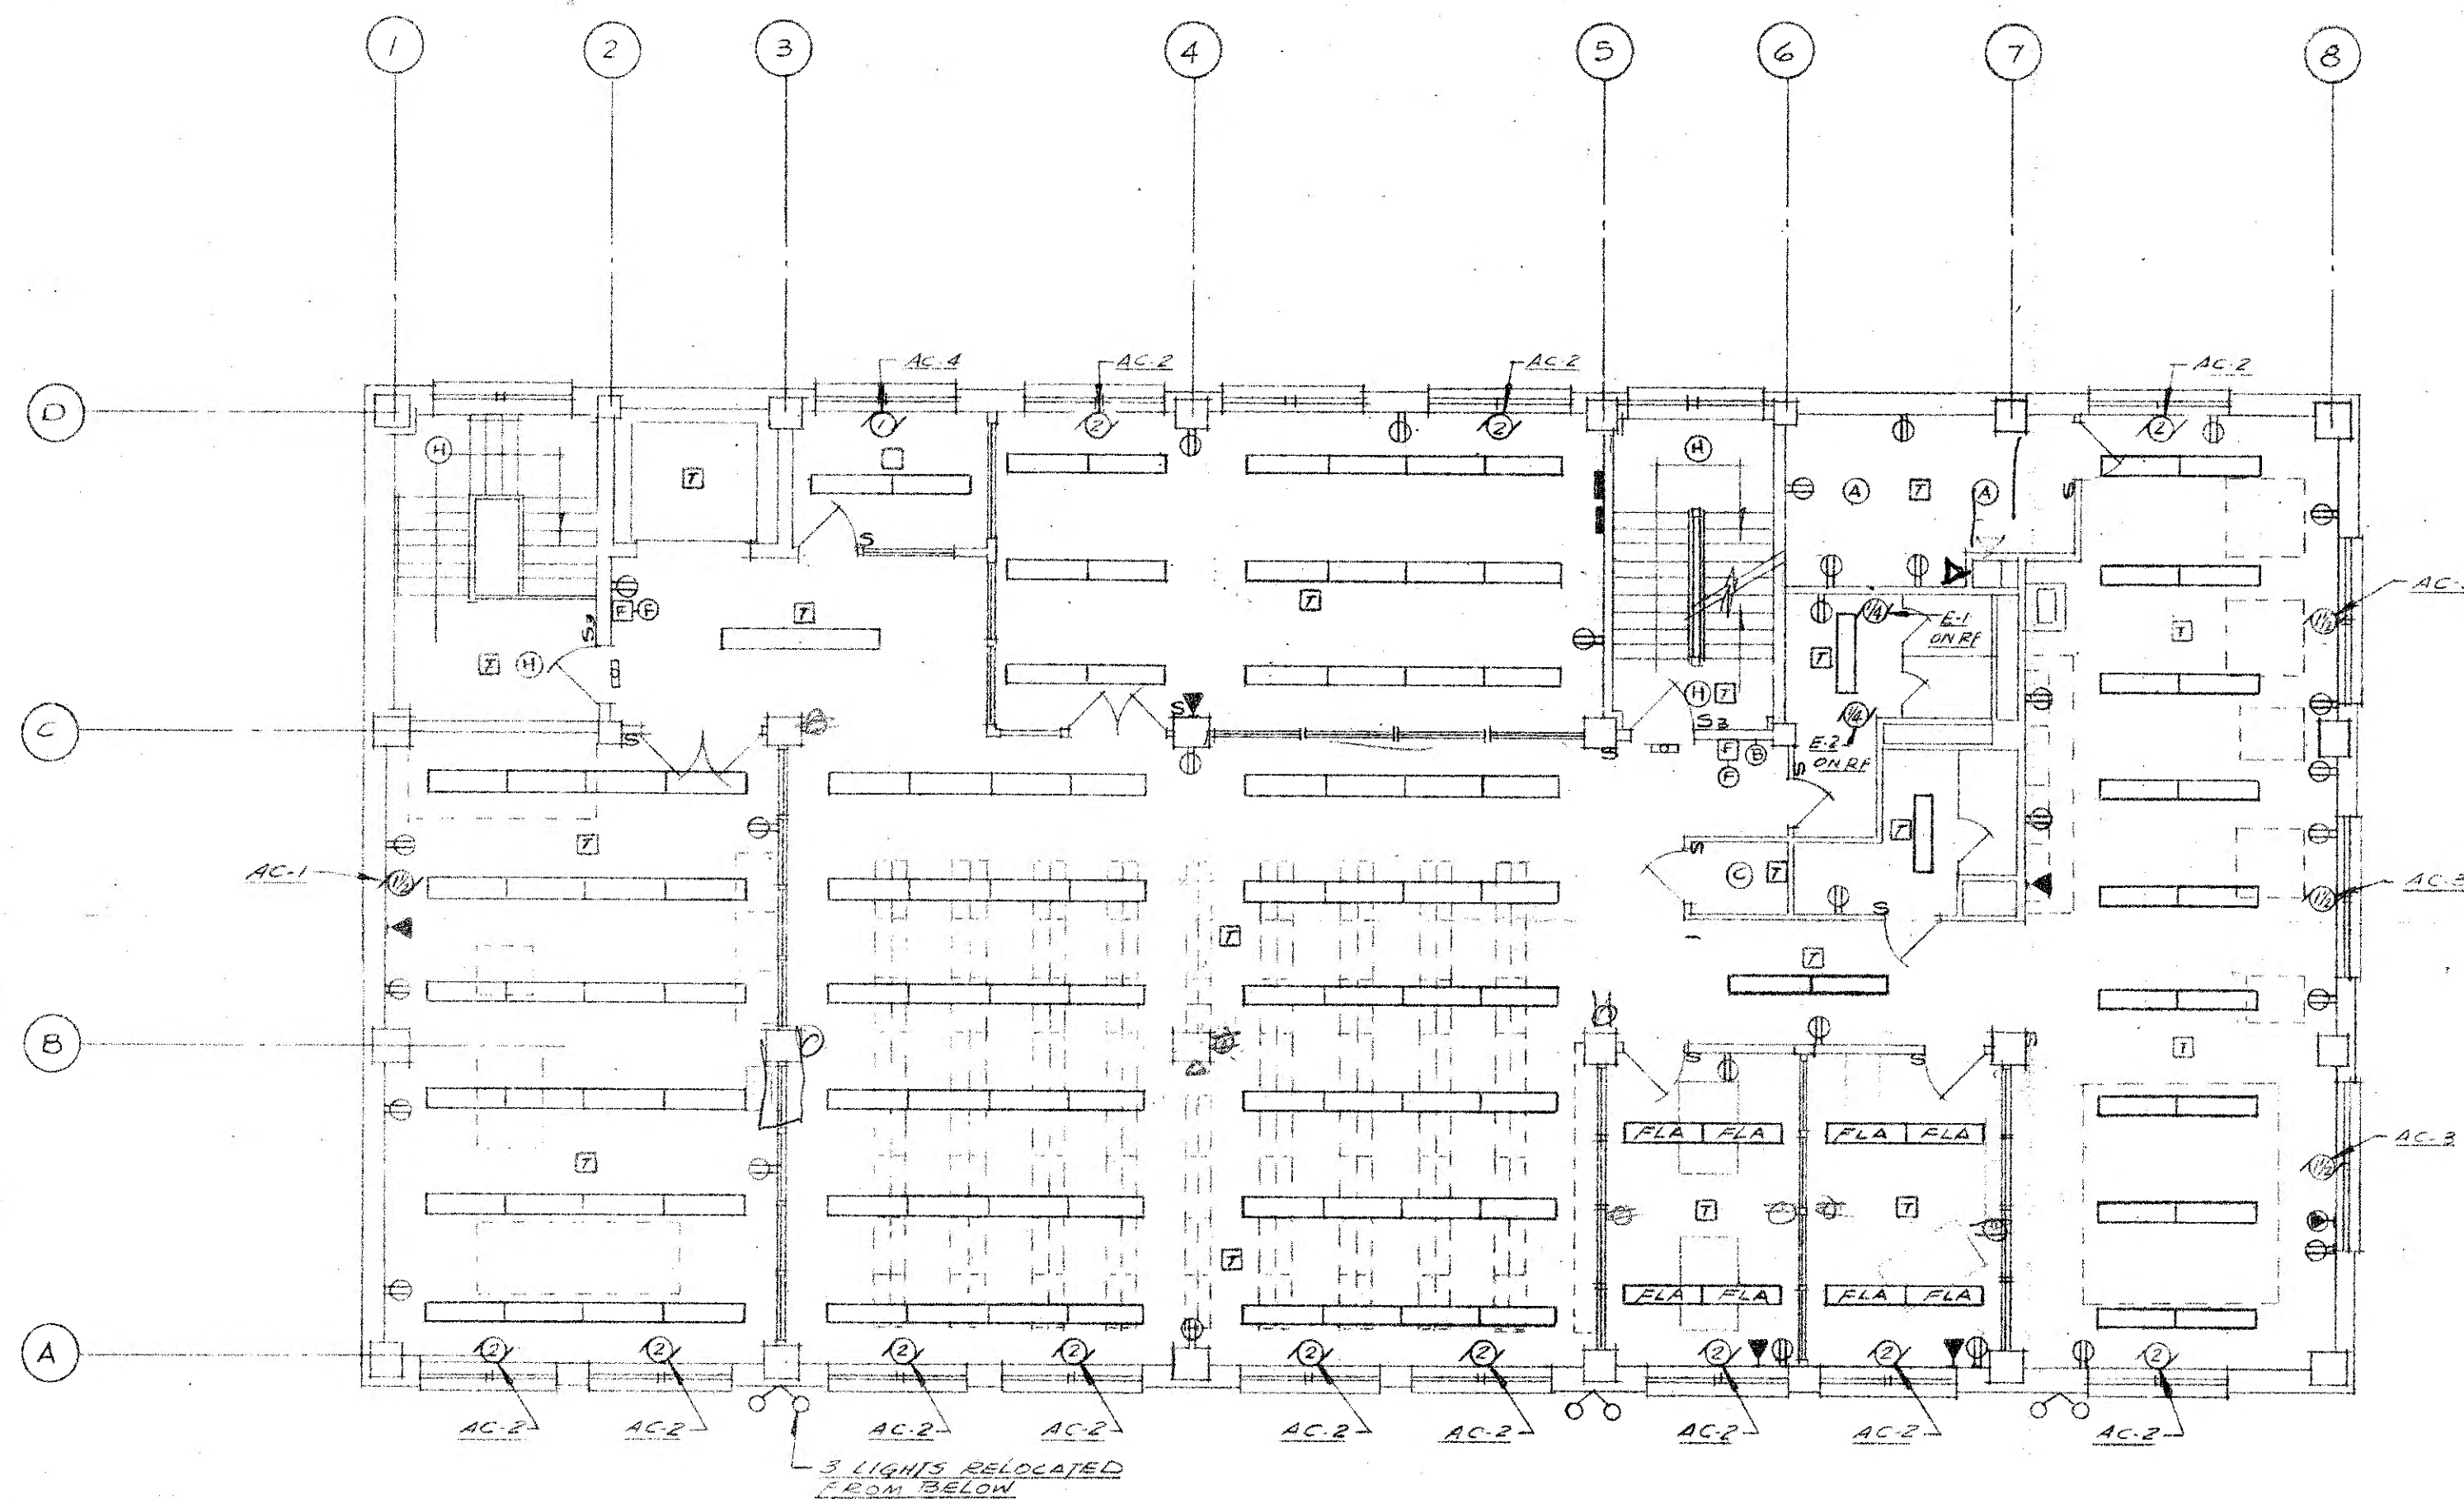

THIRD FLOOR PLAN

# SYMBOL LIST

- 2-40WATT FLUORESCENT LAMP FIXTURE
- FLA 4-40WATT FLUORESCENT LAMP FIXTURE
- INCANDESCENT LAMP
- ⊕ DUPLEX RECEPTACLE - 15" A.F.F.
- ⊙ HEAVY DUTY RECEPTACLE - 30AMPS
- ▶ TELEPHONE OUTLET
- ⊕ FIRE ALARM STATION & GONG
- ⊕ EXIT LIGHT
- ⊕ DOOR BELL
- ⊕ SINGLE POLE SWITCH
- ⊕ THREE WAY SWITCH
- ⊕ MOTOR - NUMBER INDICATES HORSE POWER
- ⊕ MOTOR STARTER
- ⊕ MOTOR DISCONNECT 3-30AMPS
- ⊕ THERMAL DETECTOR


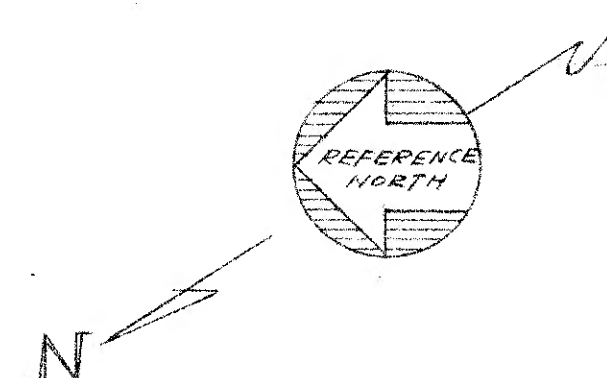


*[Handwritten signature]*

PRELIMINARY		
REVISIONS	FLOOR PLAN - ELECT.	
	PROPOSED ADDITION TO THE SERVICE BUILDING FOR THE FREE PUBLIC LIBRARY NEWARK, NEW JERSEY	
	DRAWN BY:	SCALE: 1/8" = 1'-0" DATE:
	EPPL & SEAMAN ARCHITECTS & ENGINEERS C.H. PHILIPS & B.D. KAUFMAN ASSOCIATE ARCHITECTS 901 BROAD ST. NEWARK 2, N.J.	
972		
E-1		

I. MENCHER  
CONSULTING ENGINEER  
1284 NORTH BROAD ST.  
HILLSIDE, N.J.




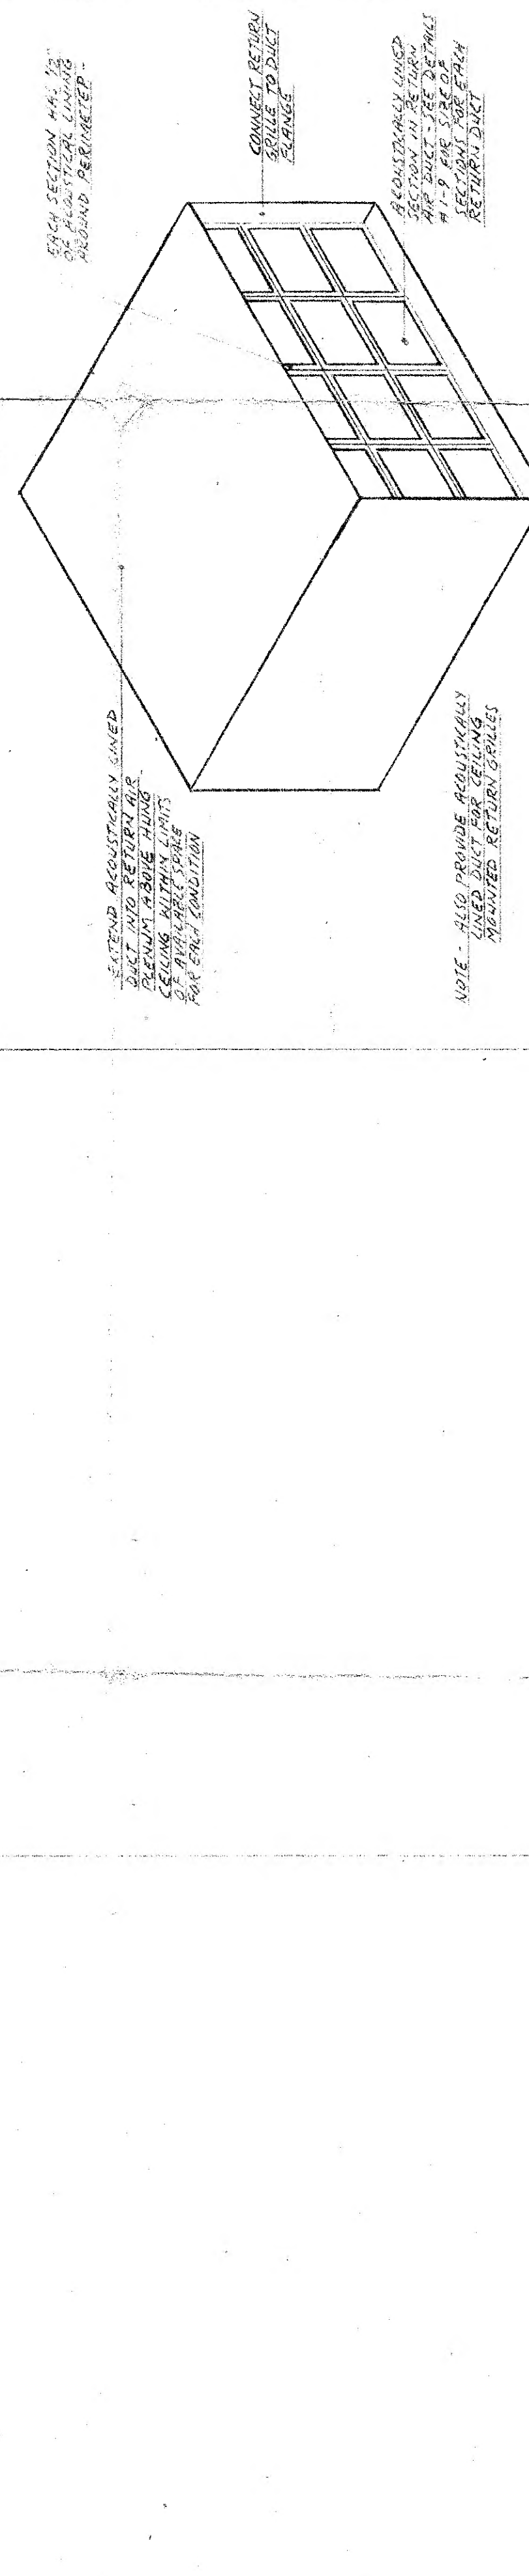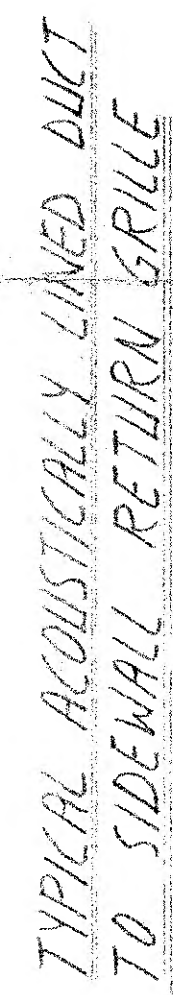









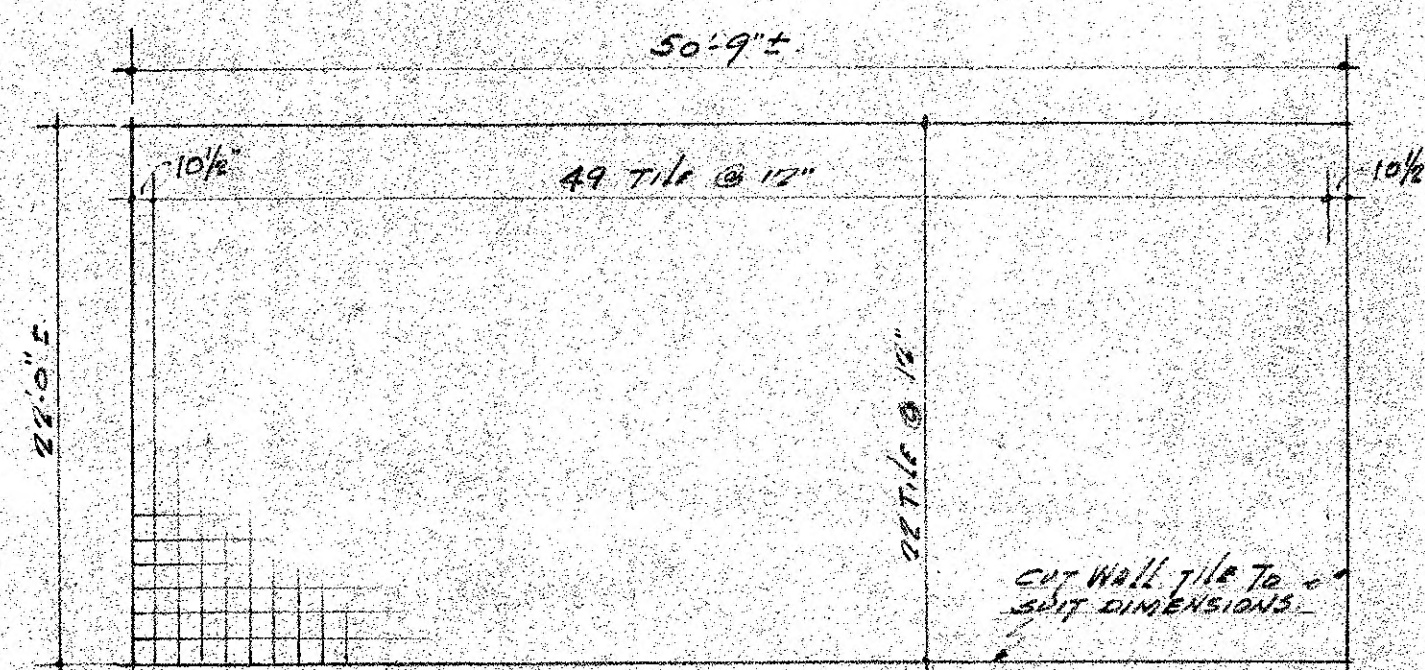


ROOM 216.

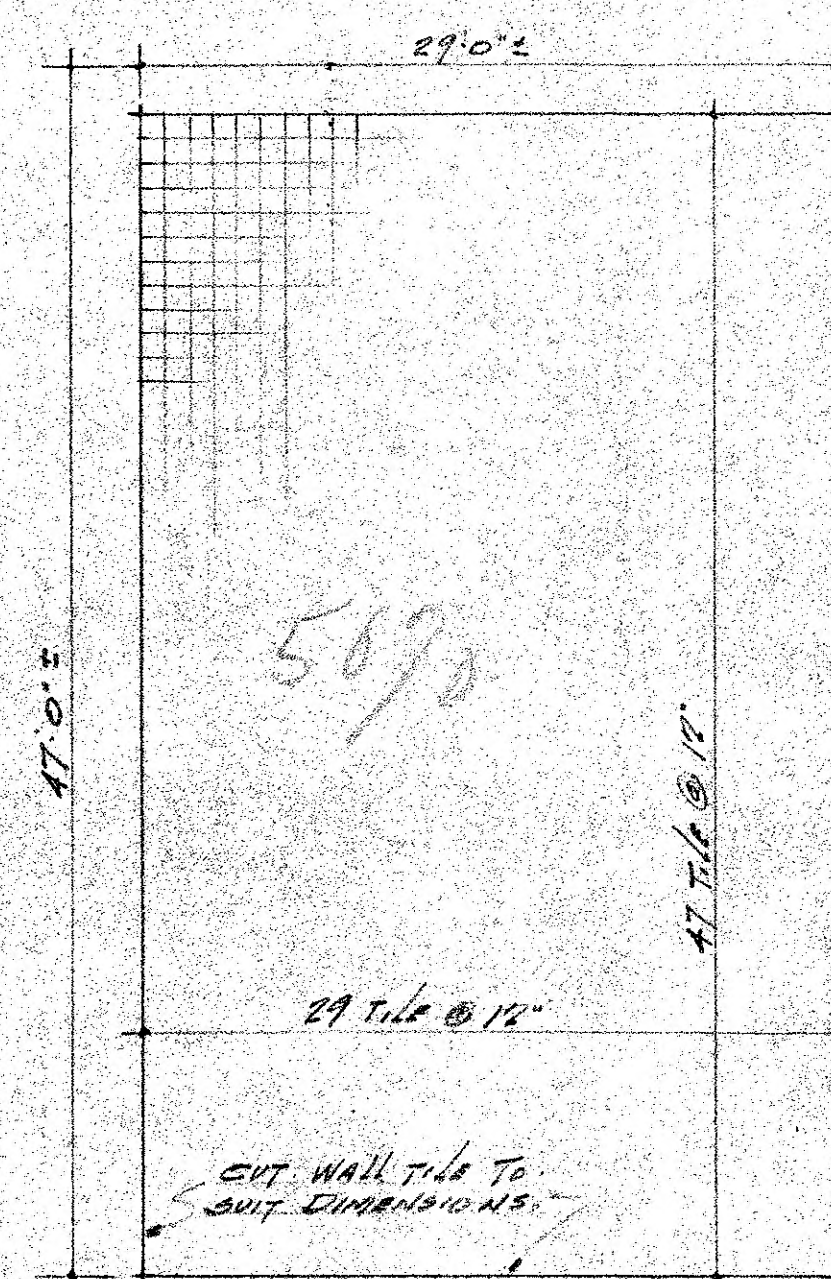


ROOM 223.

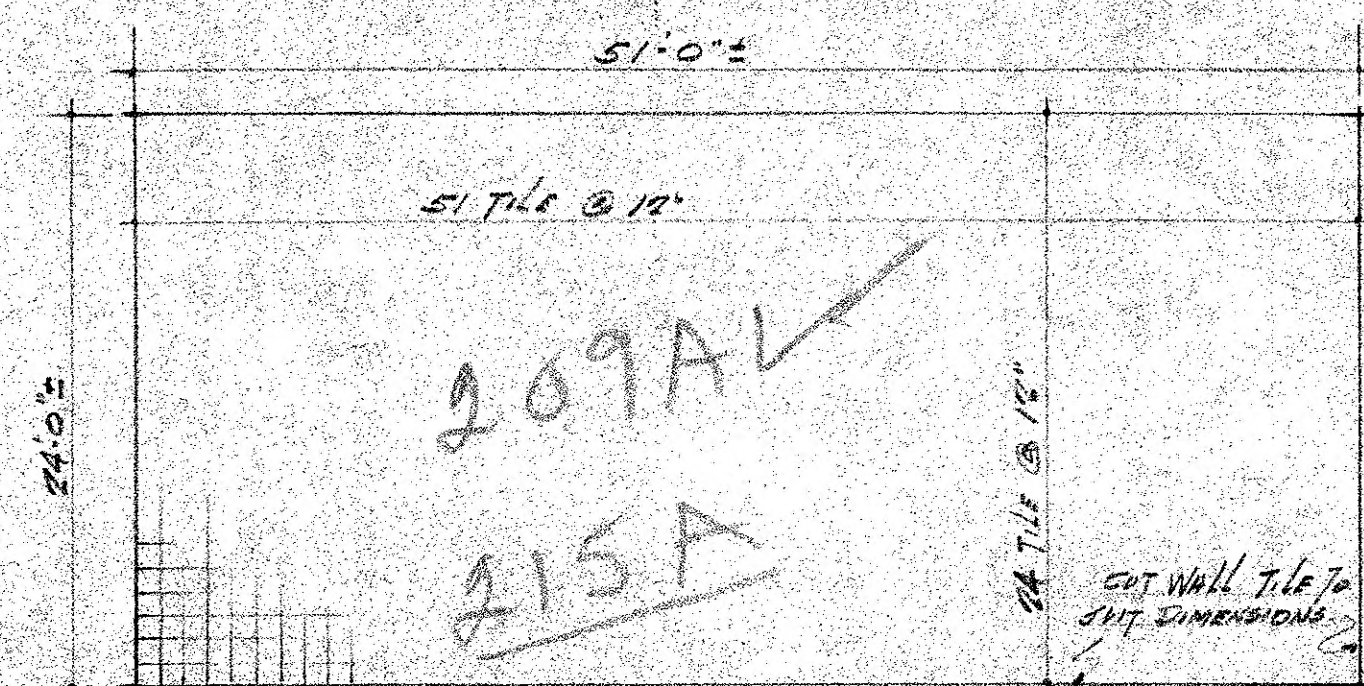


ROOM 209A  
ROOM 215A SIMILAR.

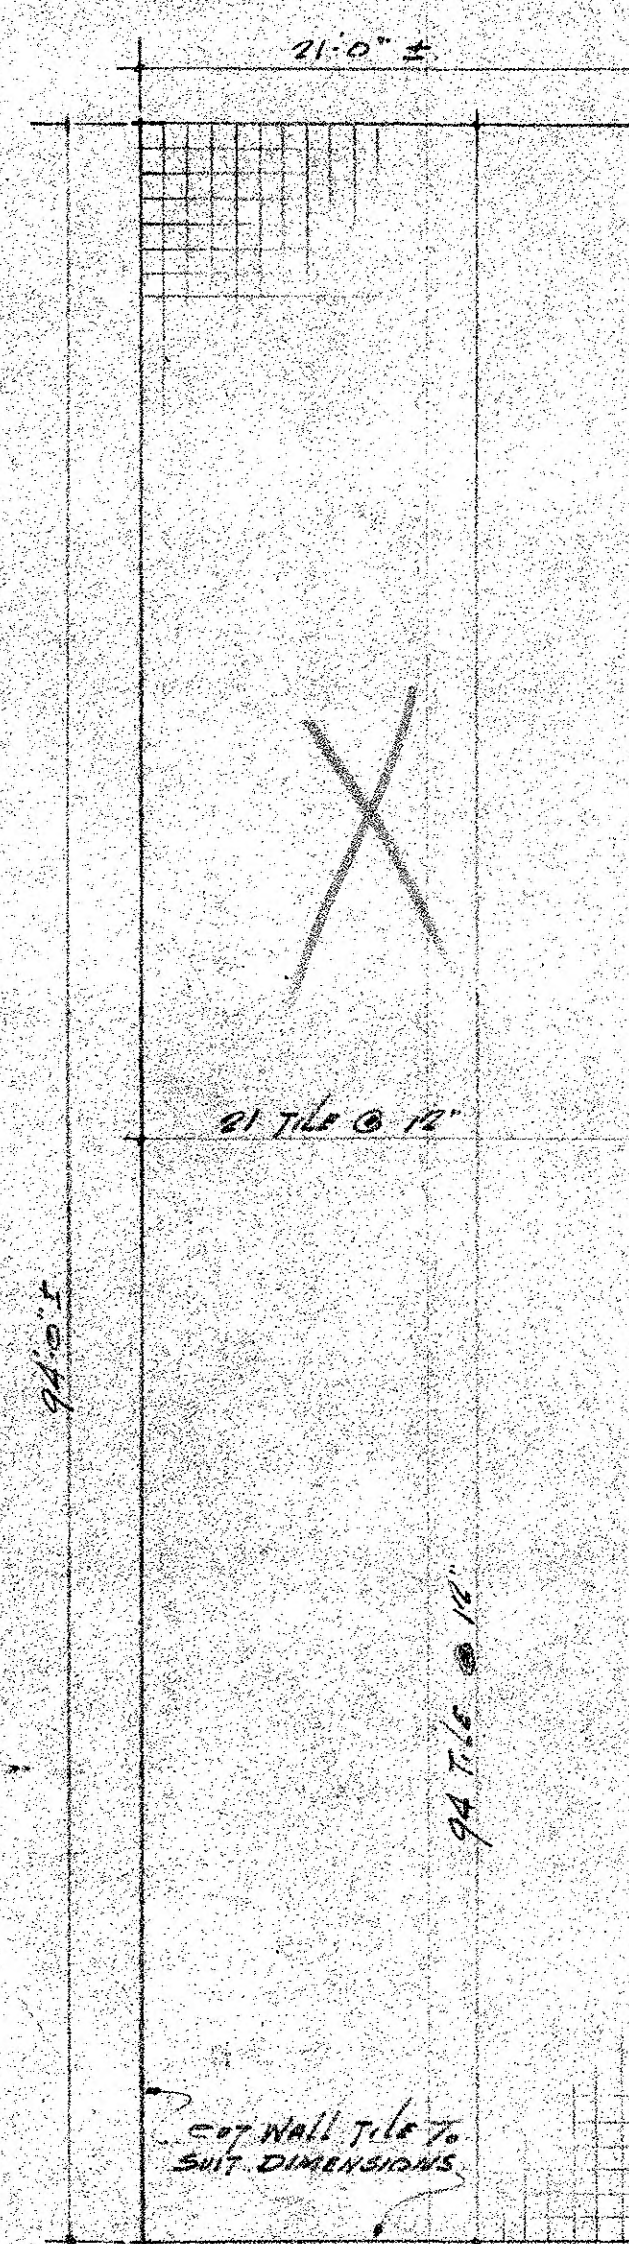


ROOM 201.

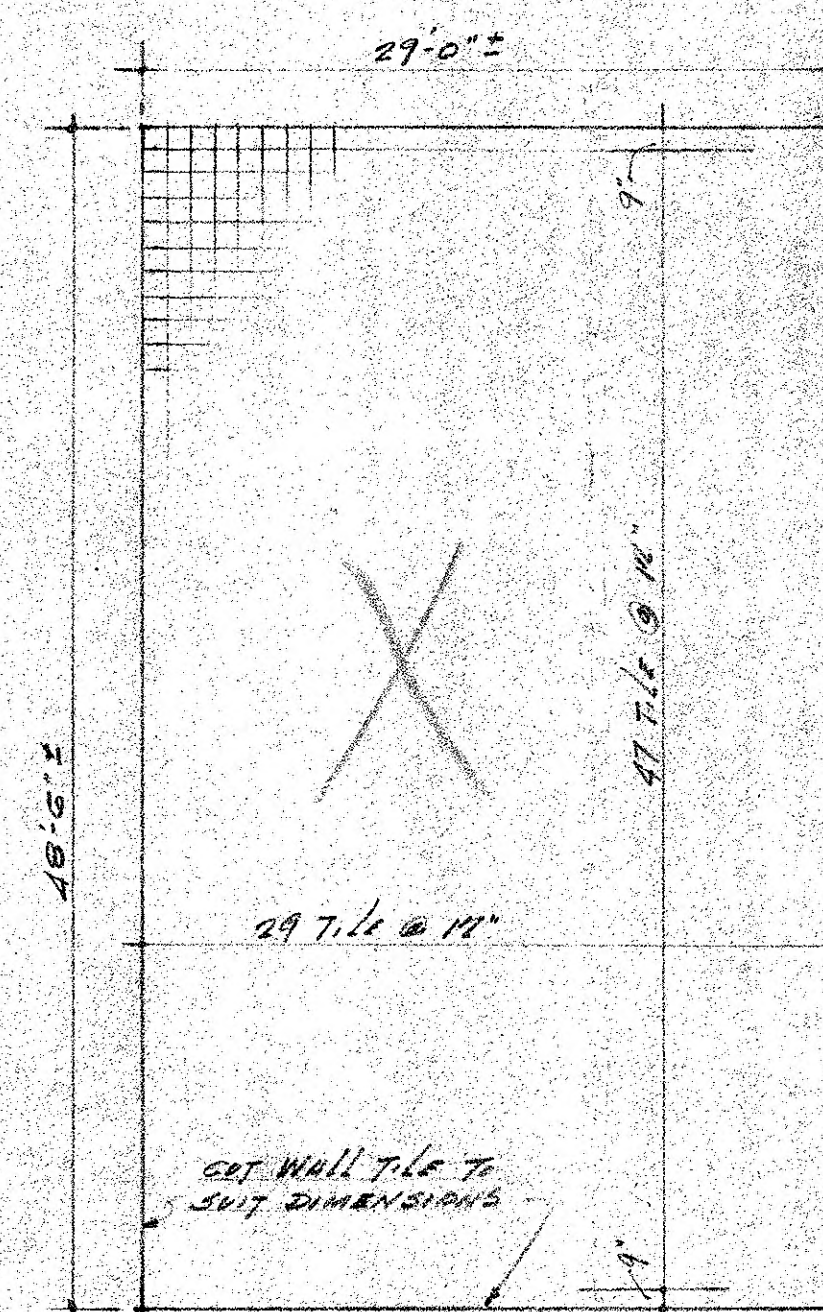


ROOM 339.

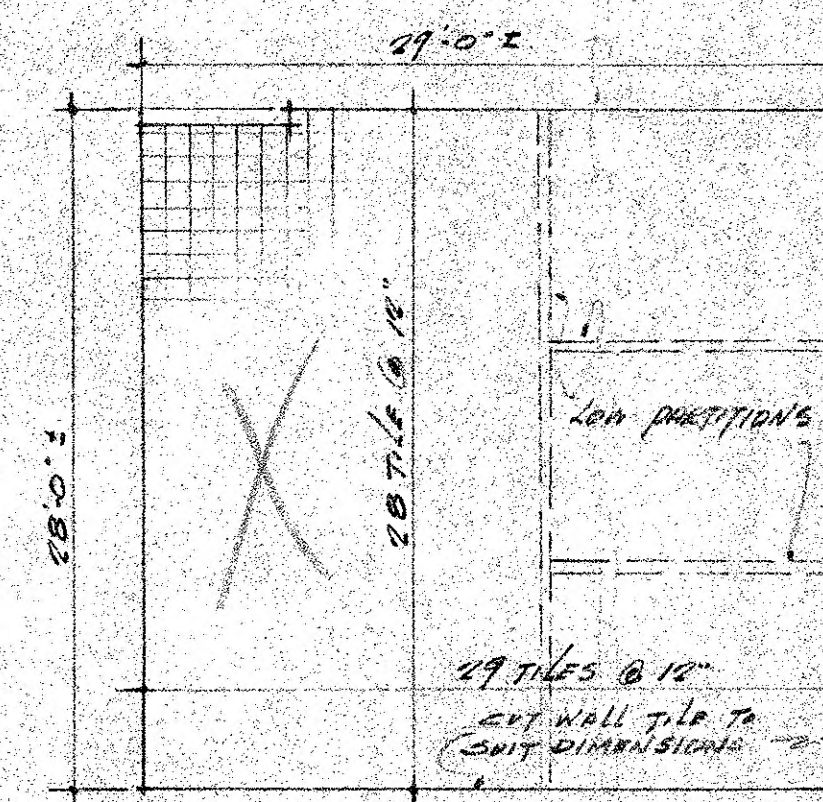


ROOMS 304 TO 307 INCL.

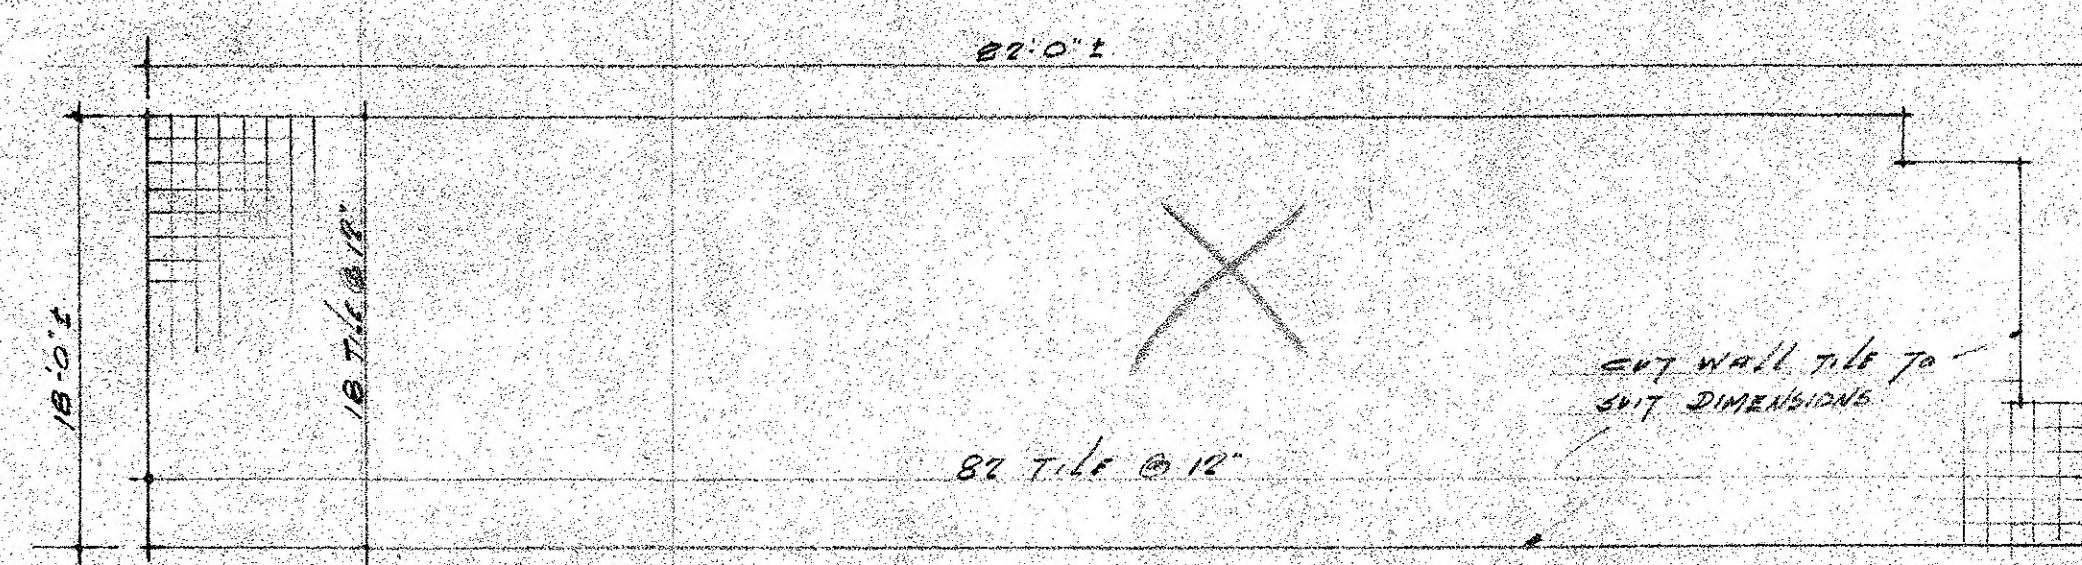


ROOM 410.

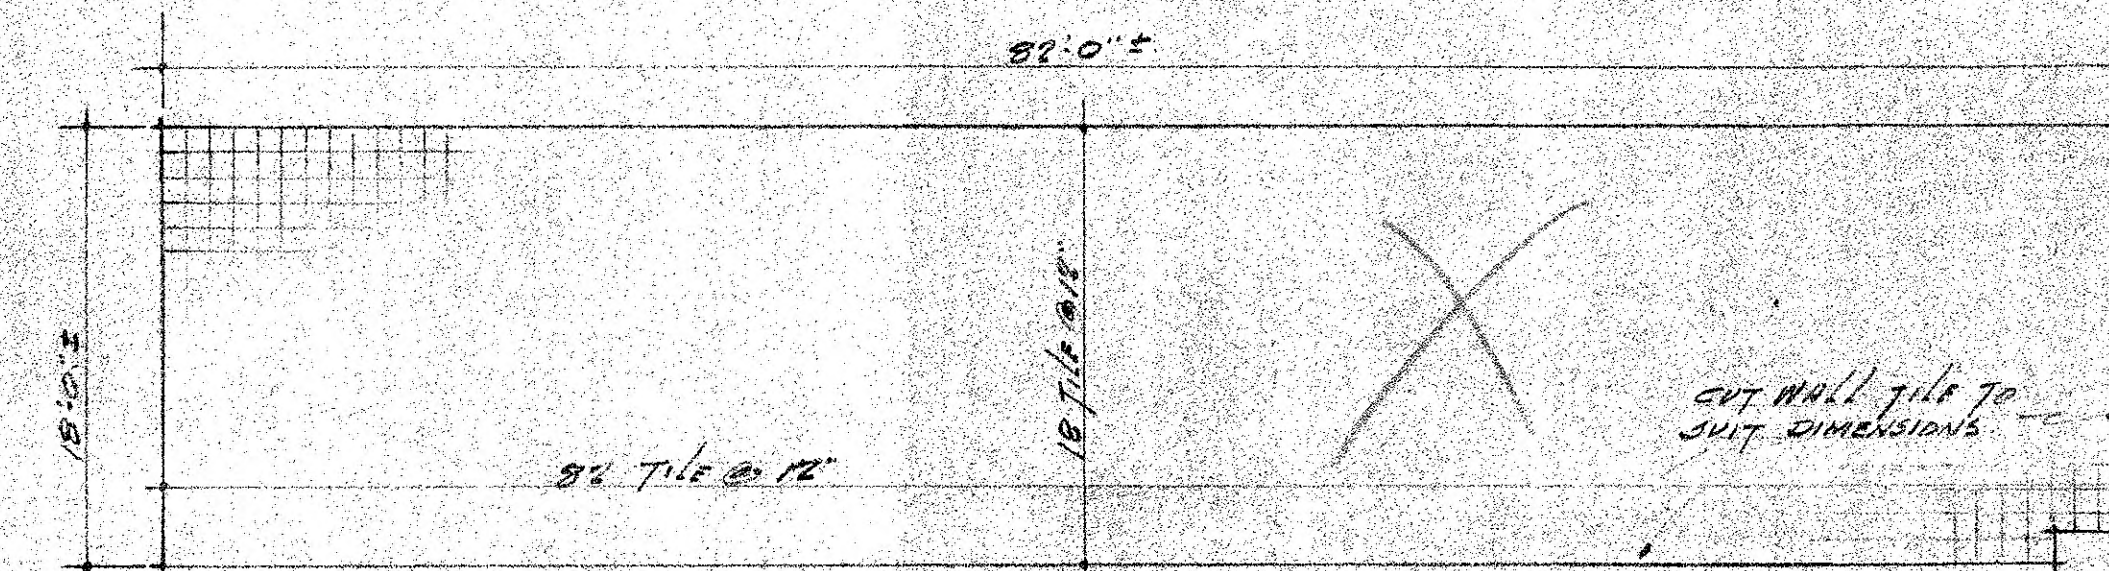


ROOM 417.

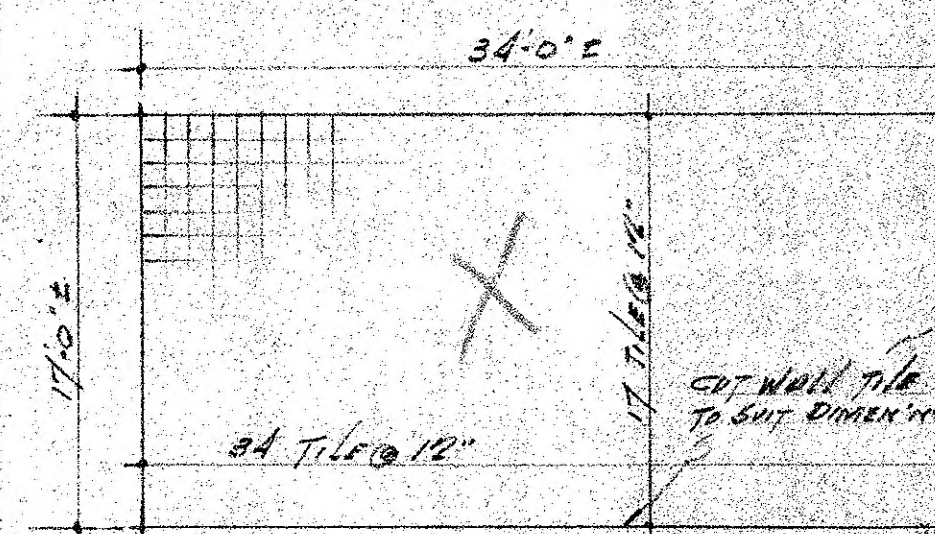


ROOM 401.

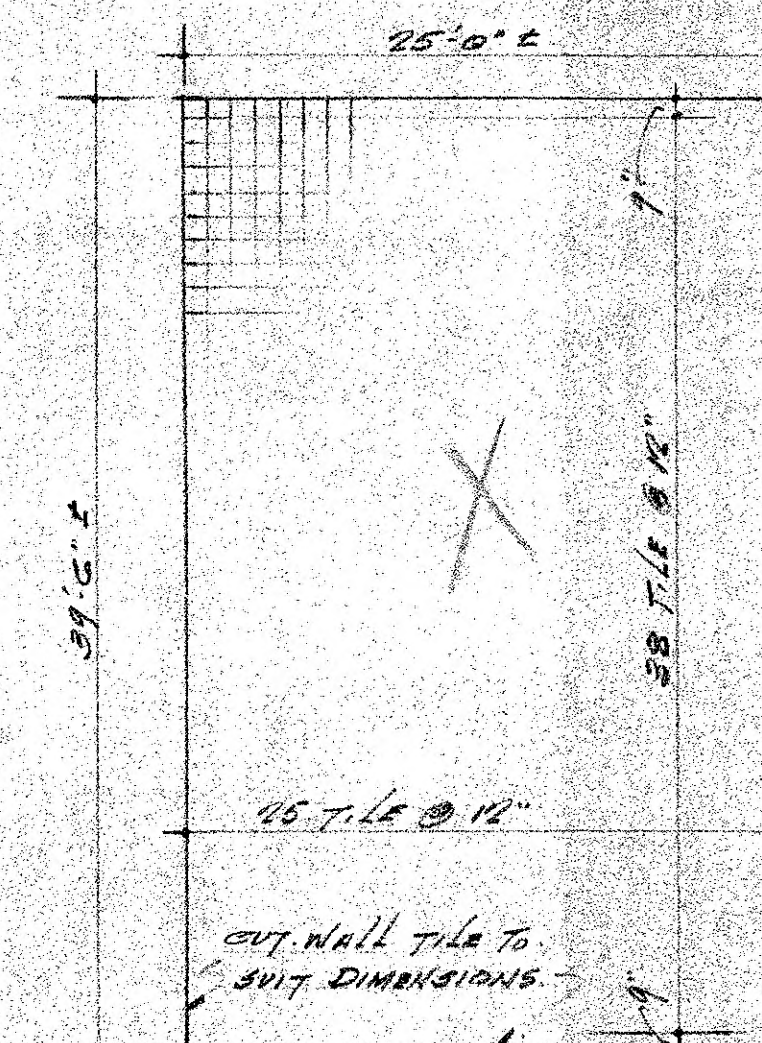

ROOM 402.

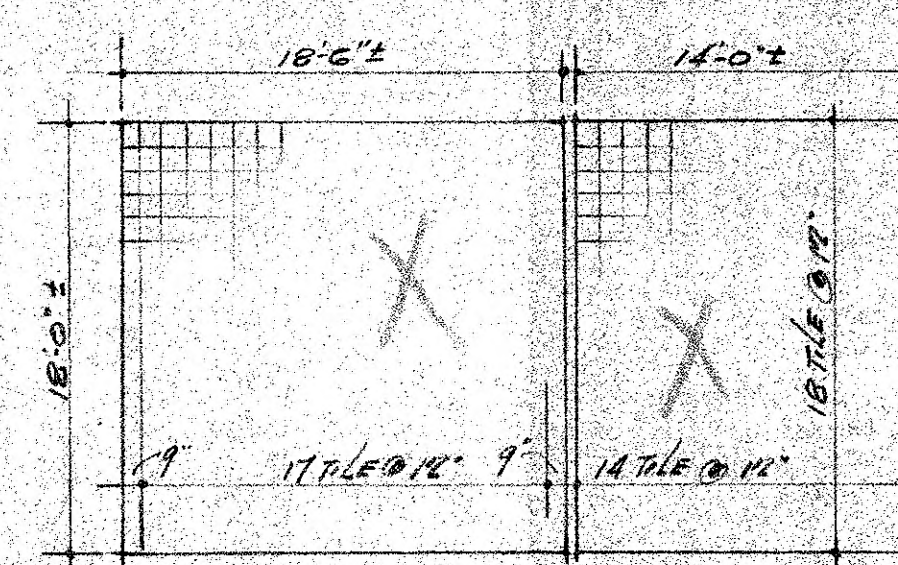

ROOM 406. ROOM 405.

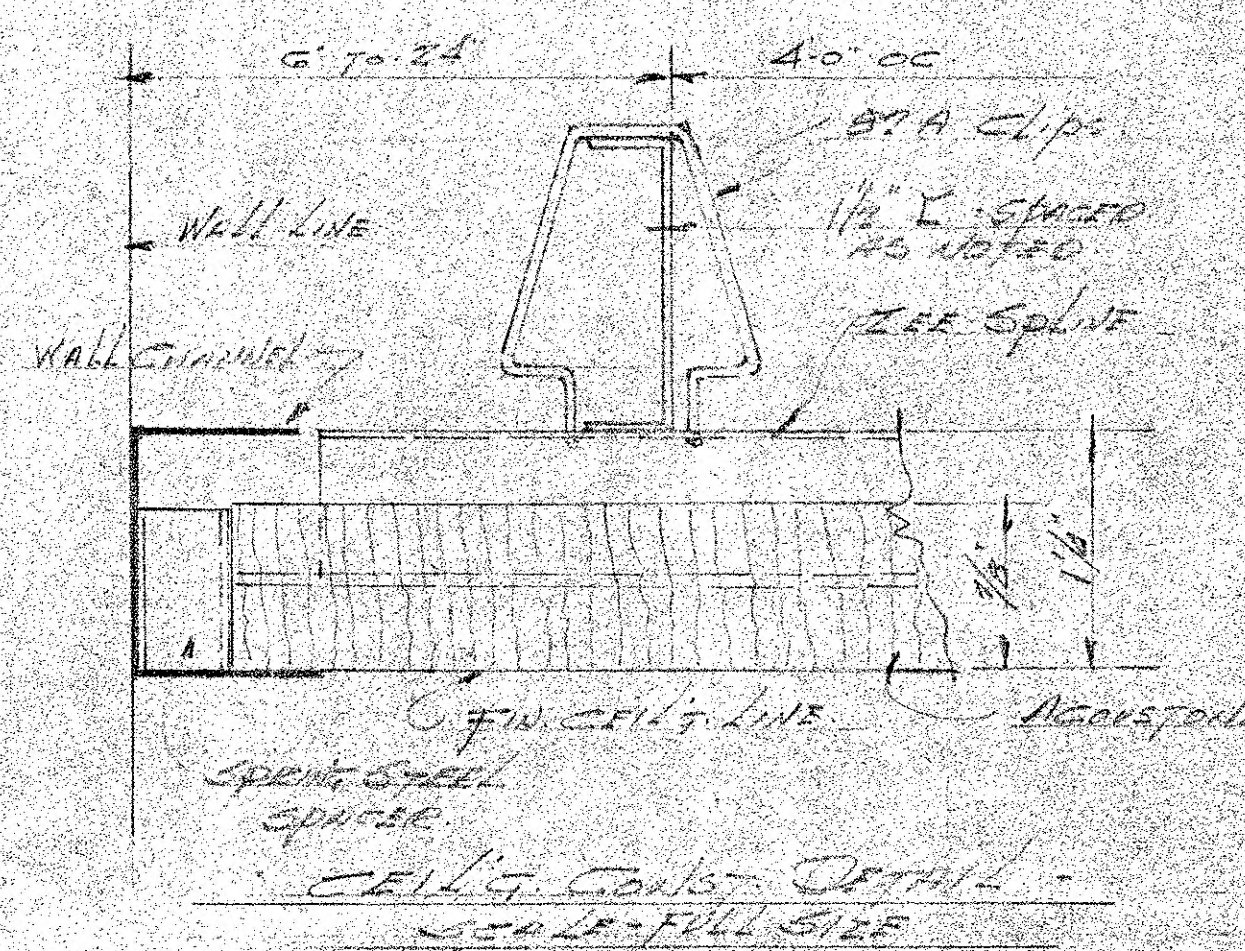

ACOUSTONE CEILING LAYOUT.  
NEWARK PUBLIC LIBRARY.  
NEWARK N.J.  
APPLE & SEAMEN HECHTS.  
BECKER CONST. CO. CONTR.  
WOODSULATE CORP.  
21 30 1624 ST. EAST ORANGE N.J.